
GRUPE PARK PARKING LOT RESURFACING

PROJECT NO. WD22011

ABBREVIATIONS

ABBREVIATION	DESCRIPTION
@	AT
AB	AGGREGATE BASE
ABS	ACRYLONITRILE-BUTADIENE-STYRENE
AC	ASPHALT CONCRETE
ВО	BLOWOFF
BOC	
BOW	BACK OF CURB BACK OF WALK
CALWATER	
	CALIFORNIA WATER SERVICE COMPANY
C,G, & SW	CURB, GUTTER, AND SIDEWALK
CB	CATCH BASIN
CL	CENTERLINE
CO	CLEANOUT
DI	DROP INLET
DIA	DIAMETER
DIP	DUCTILE IRON PIPE
DWG	DRAWING
EBOW	EXISTING BACK OF WALK
EG	EXISTING GROUND
EL	ELEVATION
EP	EDGE OF PAVEMENT, EXISTING PAVEMENT
ESDMH	EXISTING STORM DRAIN MAINTENANCE HOLE
ESMT	EASEMENT
ESSMH	EXISTING SANITARY SEWER MAINTENANCE HOLE
EX.	EXISTING
FH	FIRE HYDRANT
FL	FLOWLINE
FOC	FACE OF CURB
FT.	FEET
G	GROUND
GB	GRADE BREAK
HP	HIGH POINT
ID	INSIDE DIAMETER
IN.	INCH
INV	INVERT
LF	LINEAL FEET
LH LP	LAMP HOLE
LP LT	LOW POINT
MAX	LEFT MAXIMUM
MH	MAINTENANCE HOLE
MIN	MINIMUM
MUD	MUNICIPAL UTILITIES DEPARTMENT
NAVD	NORTH AMERICAN VERTICAL DATUM
NO.	NUMBER
NRCP	NON-REINFORCED CONCRETE PIPE
NTS	NOT TO SCALE
OD	OUTSIDE DIAMETER
P	PAVEMENT
PG&E	PACIFIC GAS AND ELECTRIC COMPANY
PL	PROPERTY LINE
PP	POWER POLE
PT	POINT
PUE	PUBLIC UTILITY EASEMENT
PVC	POLYVINYL CHLORIDE
R	RADIAL OR RADIUS
R/W	RIGHT-OF-WAY
RC	ROLL-CURB
RT	RIGHT
SD	STORM DRAIN
SDMH	STORM DRAIN MAINTENANCE HOLE
SHT	SHEET
SJC	SAN JOAQUIN COUNTY
SPECS	SPECIFICATIONS
SS	SANITARY SEWER
SSCO	SANITARY SEWER CLEANOUT
SDDI	STORM DRAIN DROP INLET
SSMH	SANITARY SEWER MAINTENANCE HOLE
STA	STATION
STD	STANDARD
SW	SIDEWALK
TC	TOP OF CURB
TFMR.	TRANSFORMER
TI	TRAFFIC INDEX
TOW	TOP OF WALL
TYP	TYPICAL
U.S.A.	UNDERGROUND SERVICE ALERT
VCP	VITRIFIED CLAY PIPE
W	WATER
WV	WATER VALVE

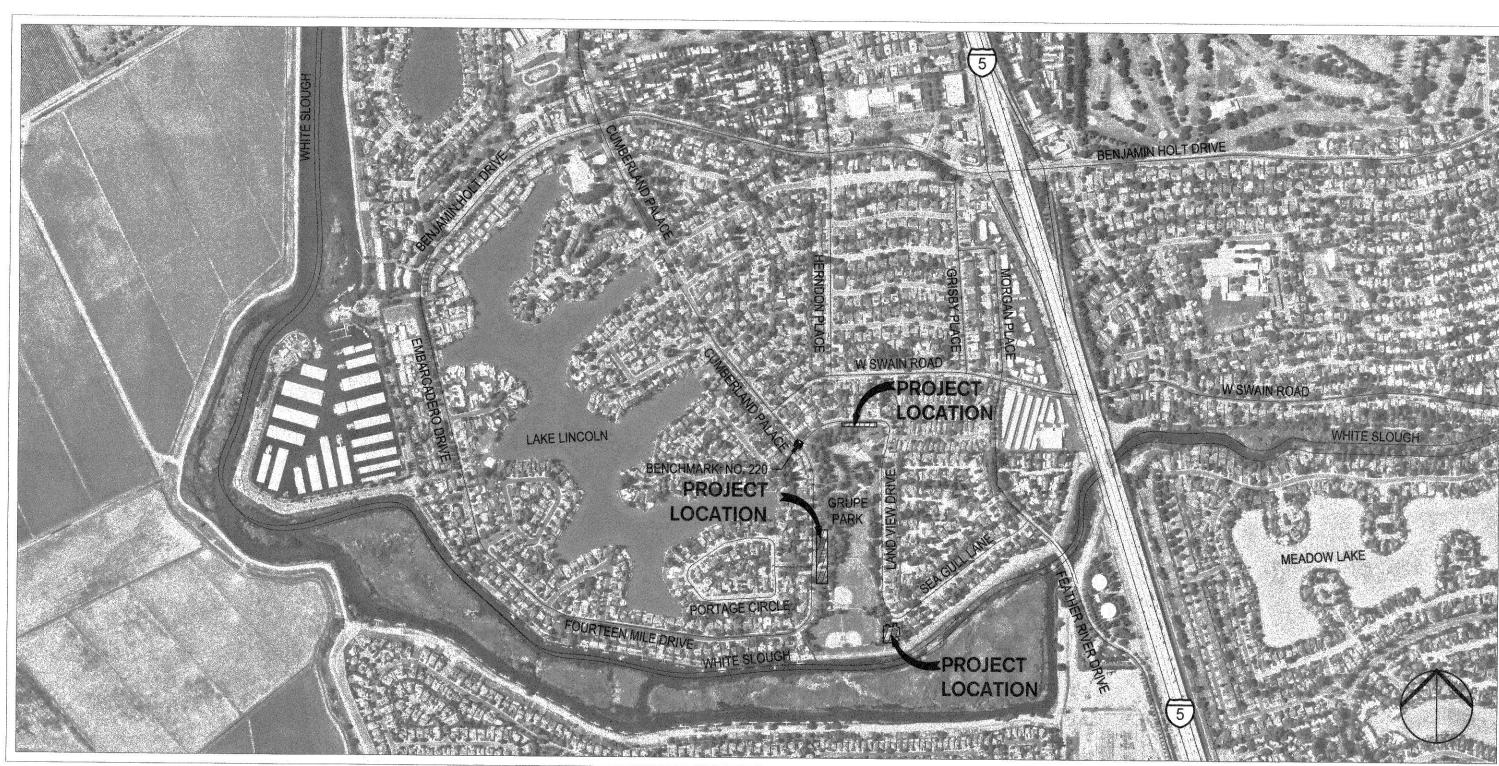

VICINITY MAP

NOT TO SCALE

EGEND EXISTING		
commence operated and produce and an extension of the second of the seco	ELECTRICAL CONDUIT	
3.0	GROUND CONTOUR	PROPOSED
	TOP OF CURB ELEVATION FLOW LINE ELEVATION	0.0
	PAVEMENT ELEVATION	3.0
	CONCRETE ELEVATION	11.43FL 15.50P
	PROPERTY & R/W LINE	45.500
<u>21"SS</u> >	SANITARY SEWER LINE	15.50C
12"SD>	STORM DRAIN LINE	
4"W	WATER LINE	
i	FIRE HYDRANT LINE	
	STREET LIGHT	
$\textstyle (\!$	SITE LIGHT	
	CLEANOUT OR LAMPHOLE	
	OVERFLOW AREA DRAIN	
	DRAINAGE INLET	
Control of the contro	CATCH BASIN	
	GATE VALVE	
	FIRE HYDRANT	
Q	SIGN	
W	WATER METER	
	BACKFLOW PREVENTER	
\circ	MAINTENANCE HOLE	
SHEET IND	EX	
SHEET NO.	DESCRIPTION	
1	COVER SHEET	
2	GENERAL NOTES	
3	OVERALL SITE PLAN	
4	DEMOLITION PLAN-MEADE DRIVE	
5	DEMOLITION PLAN-CUMBERLAND PL	
6	DEMOLITION PLAN-SEA GULL LANE	
7	PAVEMENT PLAN-MEADE DRIVE	
8	PAVEMENT PLAN-CUMBERLAND	
9	PAVEMENT PLAN-SEA GULL LANE	
10	GRADING PLAN-MEADE DRIVE	
11	GRADING PLAN-CUMBERLAND	
12	GRADING PLAN-CUMBERLAND	
13	GRADING PLAN-SEA GULL LANE	
14	EROSION CONTROL PLAN	
15	CONSTRUCTION DETAILS	

POINT	NORTHING	EASTING	ELEVATION	DESCRIPTION
220	2187356.9619	6314663.3627	-2.70	TOP 3/4" IRON PIN IN MONUMENT BOX, CENTERLINE OF CUMBERLAND PLACE AND MEADE DRIVE. COS "7N-7"



GRUPE PARK PARKING LOT RESURFACING PROJECT NO. WD22Ø11

DATE SIGNED: 11/02/23 COVER SHEET

	DATE SIGNED. 117 027 23								
	Revision No.	Description	Date	Ву	Apprvd. By			ENT OF PUBLIC WORKS STOCKTON, CALIFORNIA	,
SIEGFR						SCALE	AS SHOWN	APPROVED BY: 11/16/23	SHEET NO.
3428 Brookside Road CIVIL ENGINEE	RING					DESIGNED BY	JR	APPROVED BY: DATE	1
Stockton, CA 95219 STRUCTURAL E Phone: 209-943-2021 LANDSCAPE AR	CHITECTURE					DRAWN BY	JR /	7/20	OF 15 SHEETS
Fax: 209-942-0214 ■ LAND SURVEYII ■ PLANNING	NG					CHECKED BY	AKM	CITY ENGINEER	WD22011
www.siegfriedeng.com	LITY DESIGN					RECORD DWGS.		STOCKTON, CALIFORNIA	PROJECT NO.
				ALL CALLS	The second second second	The second secon			

CITY OF STOCKTON GENERAL NOTES

- 1. ALL IMPROVEMENTS SHALL BE CONSTRUCTED IN STRICT ACCORDANCE WITH THE FOLLOWING: CURENT CITY OF STOCKTON STANDARD SPECIFICATIONS AND PLANS, INCLUSIVE OF ALL CURENT REVISIONS AND AMENDMENTS, CALIFORNIA DEPARTMENT OF TRANSPORTATION CURRENT STANDARD PLANS AND SPECIFICATIONS (CALTRANS), INCLUSIVE OF ALL CURRENT REVISIONS AND AMENDMENTS, AND CA-MUTCD LATEST EDITION, INCLUSIVE OF ALL CURRENT REVISIONS AND AMENDMENTS THERETO. WHERE THERE IS A CONFLICT BETWEEN THE PLANS AND THE CITY'S STANDARD SPECIFICATIONS AND PLANS, THE CITY OF STOCKTON STANDARD SPECIFICATIONS AND PLANS SHALL PREVAIL. CONTRACTOR SHALL BE RESPONSIBLE FOR CONSTRUCTING THE IMPROVEMENTS IN ACCORDANCE WITH THE ABOVE-MENTIONED STANDARDS AND SPECIFICATIONS.
- 2. THE CONTRACTOR SHALL VISIT THE SITE AND BECOME FAMILIAR WITH THE COMPLETE WORK SCOPE AND ALL RELATED CONDITIONS PRIOR TO BID. ANY QUESTIONS OR DISCREPANCIES WITH THE INFORMATION SHOWN HEREIN MUST BE DIRECTED TO THE ENGINEER PRIOR TO BID.
- 3. THE CONTRACTOR SHALL BE RESPONSIBLE FOR ALL PERMITS AND LICENSES REQUIRED FOR THE CONSTRUCTIONS AND COMPLETION OF THE PROJECT AND SHALL PERFORM ALL WORK IN ACCORDANCE WITH THE REQUIREMENTS AND CONDITIONS OF ALL PERMITS AND APPROVALS APPLICABLE TO THIS PROJECT. THE CONTRACTOR SHALL ENSURE THAT THE NECESSARY PERMITS AND/OR LICENSES ARE SECURED PRIOR TO CONSTRUCTION.
- 4. CONTRACTOR SHALL OBTAIN AN ENCROACHMENT PERMIT FROM THE CITY OF STOCKTON FOR ANY WORK DONE WITHIN CITY RIGHTS-OF-WAY OR ON CITY-OWNED FACILITIES WITHIN AN EASEMENT. CONTRACTOR SHALL CALL THE PERMIT CENTER AT (209) 937-8366 TO REQUEST A CONTROL NUMBER AND ACTIVATE THE PERMIT NO LESS THAN 24 HOURS, BUT NOT IN EXCESS OF 72 HOURS PRIOR TO START OF WORK.
- 5. ALL STATIONS REFER TO DISTANCES ALONG STREET CENTERLINE, UNLESS OTHERWISE NOTED. ALL STATIONS OFF CENTERLINE ARE PERPENDICULAR TO OR RADIALLY OPPOSITE CENTERLINE STATIONS.
- 6. THE CONTRACTOR SHALL RECEIVE PRIOR APPROVAL FROM THE ENGINEER FOR ANY EXTRA WORK. THE CONTRACTOR SHALL BE HELD RESPONSIBLE FOR ANY FIELD CHANGES MADE WITHOUT PRIOR WRITTEN AUTHORIZATION FROM THE ENGINEER AT NO ADDITIONAL COST TO THE CITY.
- 7. THE CONTRACTOR SHALL BE RESPONSIBLE FOR PROTECTING FROM DAMAGE ALL EXISTING AND NEWLY PLACED IMPROVEMENTS THAT ARE TO REMAIN. SUCH IMPROVEMENTS THAT ARE DAMAGED BY THE CONTRACTOR SHALL BE REPLACED AT NO ADDITIONAL COST TO THE CITY.
- 8. THE CONTRACTOR AGREES THAT HE SHALL ASSUME SOLE AND COMPLETE RESPONSIBILITY FOR JOB SITE CONDITIONS DURING THE COURSE OF CONSTRUCTION OF THIS PROJECT INCLUDING SAFETY AND SECURITY OF JOB SITE, THAT THIS REQUIREMENT SHALL APPLY CONTINUOUSLY AND NOT BE LIMITED TO NORMAL WORKING HOURS.
- 9. THE CONTRACTOR SHALL MAINTAIN A NEATLY MARKED SET OF FULL-SIZE AS-BUILT DRAWINGS SHOWING THE FINAL LOCATION OF FINAL IMPROVEMENTS. AS-BUILT DRAWINGS SHALL REFLECT CHANGE ORDERS, ACCOMMODATIONS, AND ADJUSTMENTS TO ALL IMPROVEMENTS CONSTRUCTED. WHERE NECESSARY, SUPPLEMENTAL DRAWINGS SHALL BE PREPARED AND SUBMITTED BY THE CONTRACTOR.
- 10. PRIOR TO ACCEPTANCE OF THE PROJECT, THE CONTRACTOR SHALL DELIVER TO THE ENGINEER, ONE SET OF NEATLY MARKED AS-BUILT DRAWINGS. AS-BUILT DRAWINGS SHALL BE REVIEWED AND THE COMPLETE AS-BUILT DRAWING SET SHALL BE CURRENT WITH ALL CHANGES AND DEVIATIONS REDLINED AS A PRECONDITION TO THE FINAL PROGRESS PAYMENT APPROVAL AND/OR FINAL ACCEPTANCE.
- 11. ALL TRENCH EXCAVATION SHALL BE IN ACCORDANCE WITH SECTION 7 OF THE CITY OF STOCKTON STANDARD SPECIFICATIONS.
- 12. THE CONTRACTOR SHALL PROVIDE ALL SHORING, BRACING, SLOPING OR OTHER PROVISIONS NECESSARY TO PROTECT WORKERS FOR ALL AREAS TO BE EXCAVATED TO A DEPTH OF 5' OR MORE. EXCAVATIONS OF 5 FEET OR MORE IN DEPTH WILL REQUIRE AN EXCAVATIONS PERMIT FROM THE STATE OF CALIFORNIA DEPARTMENT OF INDUSTRIAL SAFETY FOR TRENCHES 5 FEET OR MORE IN DEPTH, THE CONTRACTOR SHALL COMPLY WITH SECTION 7-1.02K(6)(b) OF THE CALTRANS STANDARDS, SECTION 6705 OF THE STATE OF CALIFORNIA LABOR CODE, AND ANY LOCAL CODES OR ORDINANCES.
- 13. ATTENTION IS CALLED TO: SECTION 1541(b)(1) OF THE CONSTRUCTION SAFETY ORDERS (CALIFORNIA CODE OF REGULATIONS, TITLE 8), ISSUED BY THE OCCUPATIONAL SAFETY AND HEALTH STANDARDS BOARD PURSUANT TO THE CALIFORNIA OCCUPATIONAL SAFETY AND HEALTH ACT OF 1973, WHICH STATES: "THE APPROXIMATE LOCATION OF SUBSURFACE INSTALLATIONS, SUCH AS SEWER, TELEPHONE, FUEL, ELECTRIC, WATER LINES, OR ANY OTHER SUBSURFACE INSTALLATIONS THAT REASONABLY MAY BE EXPECTED TO BE ENCOUNTERED DURING EXCAVATION WORK, SHALL BE DETERMINED BY THE EXCAVATOR PRIOR TO OPENING AN EXCAVATION."
- 14. IT SHALL BE CONTRACTOR'S SOLE RESPONSIBILITY TO PROTECT ALL EXISTING UTILITIES SO THAT NO DAMAGE RESULTS TO THEM DURING THE PERFORMANCE OF HIS CONTRACT. THE CONTRACTOR SHALL BE REQUIRED TO COOPERATE WITH OTHER CONTRACTORS AND UTILITY COMPANIES INSTALLING NEW OR MODIFIED STRUCTURES. UTILITIES AND SERVICES WITHIN THE PROJECT LIMITS.
- 15. THE CONTRACTOR SHALL EXERCISE DUE CAUTION AND SHALL CAREFULLY PRESERVE BENCH MARKS, CONTROL POINTS, REFERENCE POINTS AND ALL SURVEY MONUMENTS, AND SHALL BEAR ALL EXPENSES FOR REPLACEMENT AND/OR ERROR CAUSED BY HIS UNNECESSARY LOSS OR DISTURBANCE. THE CONTRACTOR SHALL CONSULT WITH A LICENSED LAND SURVEYOR OR CIVIL ENGINEER LICENSED TO PRACTICE LAND SURVEYING IN CALIFORNIA PRIOR TO BEGINNING CONSTRUCTION TO ENSURE THAT ANY PRECONSTRUCTION CORNER RECORDS, AS REQUIRED BY THE STATE OF CALIFORNIA PROFESSIONAL LAND SURVEYOR ACT HAVE BEEN FILED WITH THE COUNTY SURVEYOR, PURSUANT TO SECTION 8771(a-f) OF THE CALIFORNIA BUSINESS AND PROFESSION CODE.
- 16. ALL WORK IN THE PUBLIC RIGHT-OF-WAY IS SUBJECT TO THE APPROVAL AND ACCEPTANCE OF THE ENGINEER.
- 17. PRIOR TO PLACEMENT OF ANY FINISH ASPHALT CONCRETE OR CONCRETE, THE CONTRACTOR SHALL VERIFY ALL FINISH GRADES AND SLOPES FOR COMPLIANCE WITH THE AMERICANS WITH DISABILITIES ACT (ADA) AND OBTAIN APPROVAL AND ACCEPTANCE BY THE ENGINEER.
- 18. THE CONTRACTOR SHALL LAYOUT IMPROVEMENTS FROM THE DIMENSIONS SHOWN ON THE PLANS, ANY CLARIFICATION OR CONFLICTS, DISCREPANCIES OR AMBIGUITIES SHALL BE DIRECTED TO THE ENGINEER PRIOR TO THE CONSTRUCTION OF THE IMPROVEMENTS.
- 19. DUST CONTROL SHALL BE PERFORMED AT ALL TIMES, AT THE CONTRACTORS' EXPENSE, TO MINIMIZE ANY DUST NUISANCE AND SHALL BE IN ACCORDANCE WITH SECTION 10-5 OF CALTRANS STANDARD SPECIFICATIONS AND THE REQUIREMENTS OF THE CITY OF STOCKTON.
- 20. THE CONTRACTOR SHALL MAINTAIN ALL EXISTING WATER, SEWER, AND DRAINAGE FACILITIES WITHIN THE CONSTRUCTION AREA UNTIL NEW IMPROVEMENTS ARE IN PLACE AND FUNCTIONING, EXCEPT WHERE OTHERWISE
- 21. INGRESS AND EGRESS BY PROPERTY OWNERS, BUSINESSES, AND OTHERS SHALL BE PROVIDED AT ALL TIMES DURING THE COURSE OF CONSTRUCTION UNLESS OTHERWISE APPROVED OR SPECIFIED.
- 22. SIDEWALK REMOVAL SHALL BE TO THE NEAREST SCORE MARK OR AS DETERMINED BY THE ENGINEER. CONTRACTOR SHALL NEATLY SAW-CUT CONCRETE WHERE PULL BOXES ARE TO BE PLACED AND SHALL RESTORE THE SLAB TO MATCH THE EXISTING CONDITION.

STRIPING AND SIGNAGE NOTES:

- 1. THE CONTRACTOR SHALL PROVIDE ALL LIGHTS, BARRICADES, SIGNS, FLAGMEN OR OTHER DEVICES NECESSARY FOR PUBLIC SAFETY.
- 2. THE CONTRACTOR SHALL SUBMIT A TRAFFIC CONTROL AND/OR DETOUR PLAN FOR APPROVAL BY THE CITY OF STOCKTON TRAFFIC ENGINEER PRIOR TO THE START OF CONSTRUCTION.
- 3. ALL PAVEMENT MARKINGS, STRIPING AND CROSSWALKS SHALL BE THERMOPLASTIC.
- 4. STRIPING AND PAVEMENT MARKINGS SHALL BE IN STRICT CONFORMANCE WITH THE CA-MUTCD (LATEST EDITION) AND THE SPECIAL PROVISIONS SECTION 84. LONGITUDINAL STRIPING EXCLUDED, PAVEMENT MARKINGS SHALL ALSO CONFORM TO THE CALTRANS SPECIFICATIONS (LATEST EDITION) SECTION 84.
- 5. SIGNING SHALL CONFORM TO THE CA-MUTCD (LATEST EDITION) AND CALTRANS SPECIFICATIONS (LATEST EDITION) SECTION 82.
- 6. REMOVAL OF EXISTING PAVEMENT MARKINGS SHALL BE REMOVED BY GRINDING PER CALTRANS STANDARDS SPECIFICATIONS SECTION 84-9.
- 7. CONTRACTOR SHALL INSTALL A BLUE REFLECTOR ON FIRE HYDRANT SIDE AT ALL FIRE HYDRANT LOCATIONS PER CA-MUTCD, SECTION 3B.11 AND FIGURE 3B-102.
- 8. THE CONTRACTOR SHALL NOTIFY THE ENGINEER A MINIMUM OF THREE (3) WORKING DAYS IN ADVANCE OF THE LAYOUT AND CAT-TRACKING OF THE PROPOSED IMPROVEMENTS. CAT-TRACKING TO BE APPROVED BY TRAFFIC ENGINEERING PRIOR TO FINAL ACCEPTANCE OF STRIPING AND PAVEMENT MARKINGS.
- THE CONTRACTOR SHALL ENSURE THAT THE APPROPRIATE STRIPING AND PAVEMENT MARKINGS ARE IN PLACE AT ALL TIMES. TEMPORARY STRIPING AND/OR PAVEMENT MARKINGS SHALL BE INSTALLED TO REPLACE ANY EXISTING STRIPING OR MARKINGS WHICH HAVE BEEN REMOVED. ANY CONFLICTING STRIPING SHALL BE REMOVED IMMEDIATELY BY THE CONTRACTOR PRIOR TO REOPENING THE STREET TO TRAFFIC.
- 10. THE CONTRACTOR SHALL REMOVE ANY EXISTING SIGNS IN CONFLICT WITH THESE PLANS AS DIRECTED BY THE CITY TRAFFIC ENGINEER. EXISTING STRIPING AND MARKINGS IN CONFLICT WITH THESE PLANS SHALL BE REMOVED BY THE CONTRACTOR. PAVEMENT SHALL BE REPAIRED IF DAMAGED IN CONJUNCTION WITH REMOVAL OF MARKERS.
- 11. ALL DIMENSIONS SHOWN ARE FROM FACE OF CURB, UNLESS OTHERWISE NOTED.
- 12. THE CONTRACTOR SHALL REPLACE ANY PAVEMENT DELINEATION AND TRAFFIC MARKINGS THAT ARE DAMAGED DURING THE COURSE OF WORK AT NO ADDITIONAL COST TO THE CITY.
- 13. CONSTRUCTION PERIMETER FENCING SHALL BE FURNISHED, INSTALLED AND REMOVED IN ACCORDANCE WITH CALTRANS STANDARD SPECIFICATION SECTIONS 16, TEMPORARY FACILITIES AND SECTION 80, FENCES AND THE PROJECT PLANS AND SPECIFICATIONS.

GEOTECHNICAL NOTES

- 1. CONTRACTOR TO REFERENCE GEOTECHNICAL INVESTIGATION FOR ALL SUBGRADE PREPARATION, PAVEMENT RECOMMENDATIONS, SLAB ON GRADE THICKNESS, ETC. AND COMPARE WITH ANY RECOMMENDATIONS ON THE PLANS, IF ANY DISCREPANCIES EXISTING NOTIFY THE
- 2. GEOTECHNICAL ENGINEERING SERVICES INVESTIGATION PREPARED BY SIEGFRIED ENGINEERING, DATED JANUARY 27, 2023.

BENCHMARK:

Stockton, CA 95219

Phone: 209-943-2021

Fax: 209-942-0214

www.siegfriedeng.com

TOP 3/4" IRON PIN IN MONUMENT BOX, CENTERLINE OF CUMBERLAND PL AND MEADE DR. COS "7N-7". BENCH MARK NO. 220 ELEV. = -2.70 FEET (2008 CITYWIDE BENCHMARK VERTICAL DATUM CONVERSION TO NAVD88)


PLANNING




GRUPE PARK PARKING LOT RESURFACING PROJECT NO. WD22011

DATE SIGNED: 11/02/23

GENERAL NOTES DEPARTMENT OF PUBLIC WORKS Description CITY OF STOCKTON. CALIFORNIA SIEGFRIED DESIGNED BY JR CIVIL ENGINEERING STRUCTURAL ENGINEERING DRAWN BY JR / M LANDSCAPE ARCHITECTURE M LAND SURVEYING CHECKED BY CITY ENGINEER M ATHLETIC FACILITY DESIGN RECORD DWGS. STOCKTON, CALIFORNIA

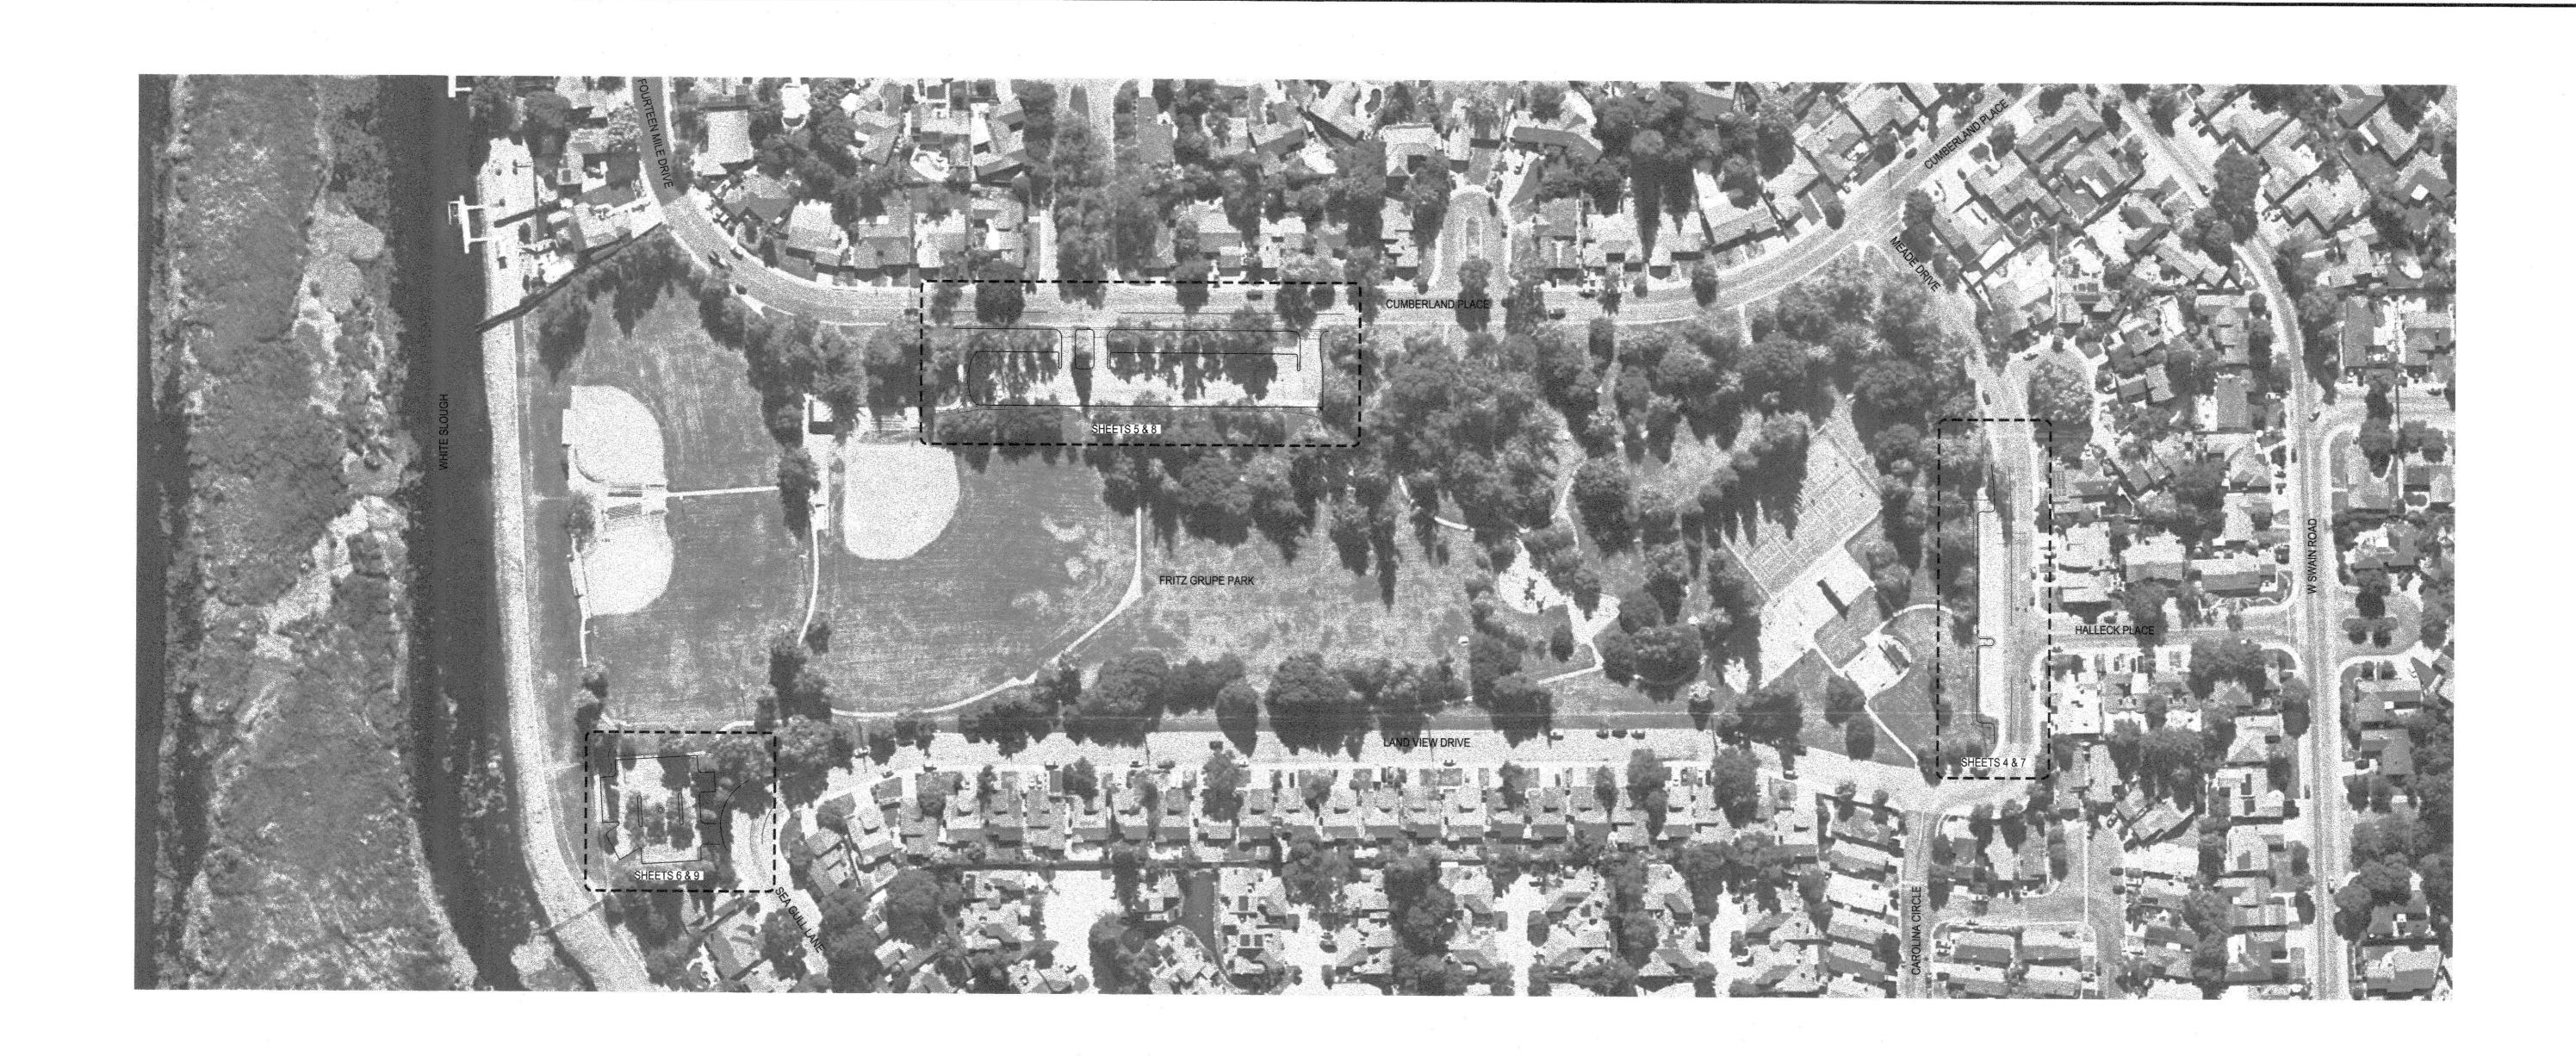

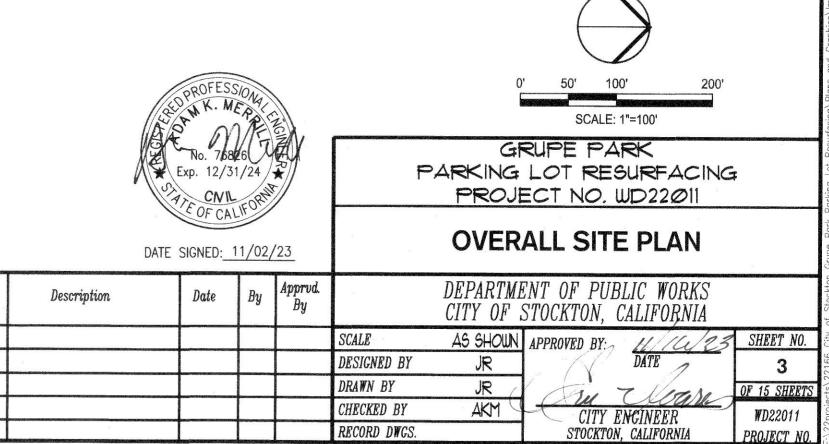



3428 Brookside Road
Stockton, CA 95219
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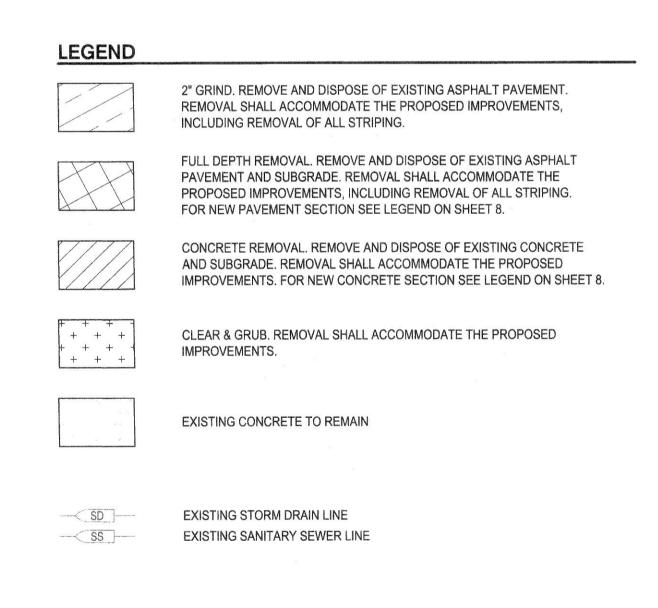
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CIVIL ENGINEERING
STRUCTURAL ENGINEERING
LANDSCAPE ARCHITECTURE
LAND SURVEYING
PLANNING
ATHLETIC FACILITY DESIGN





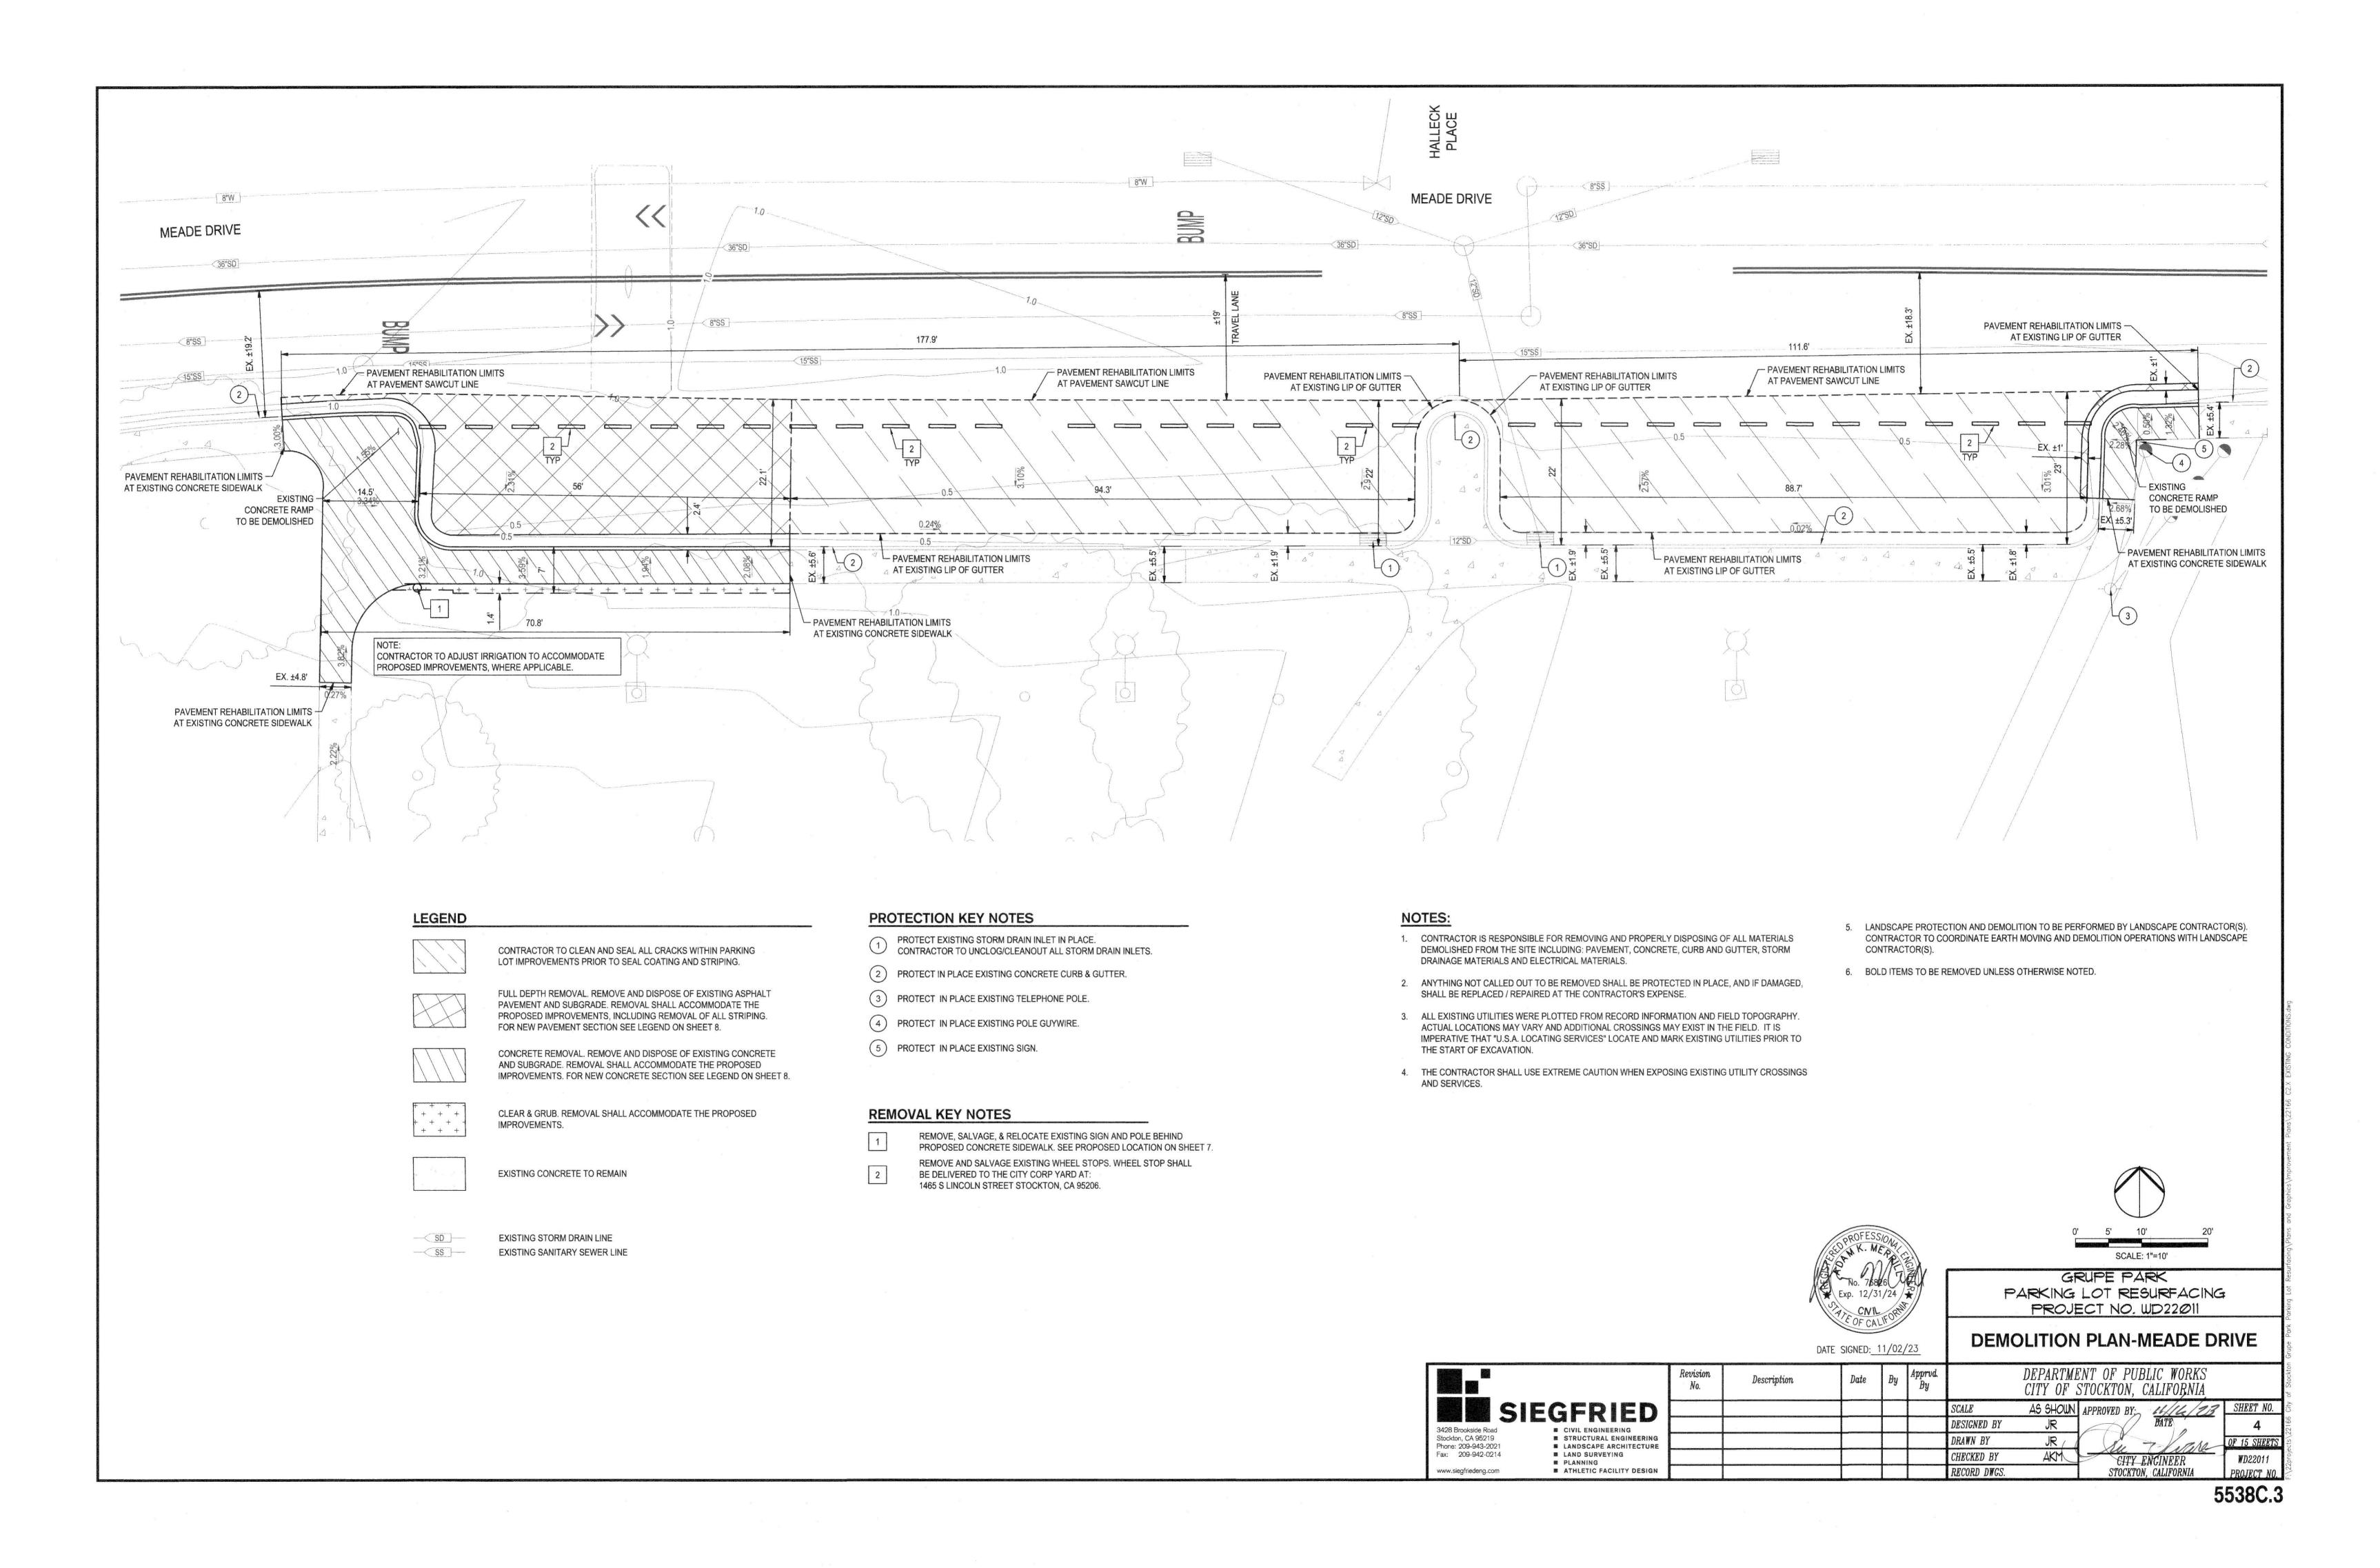

NOTES:

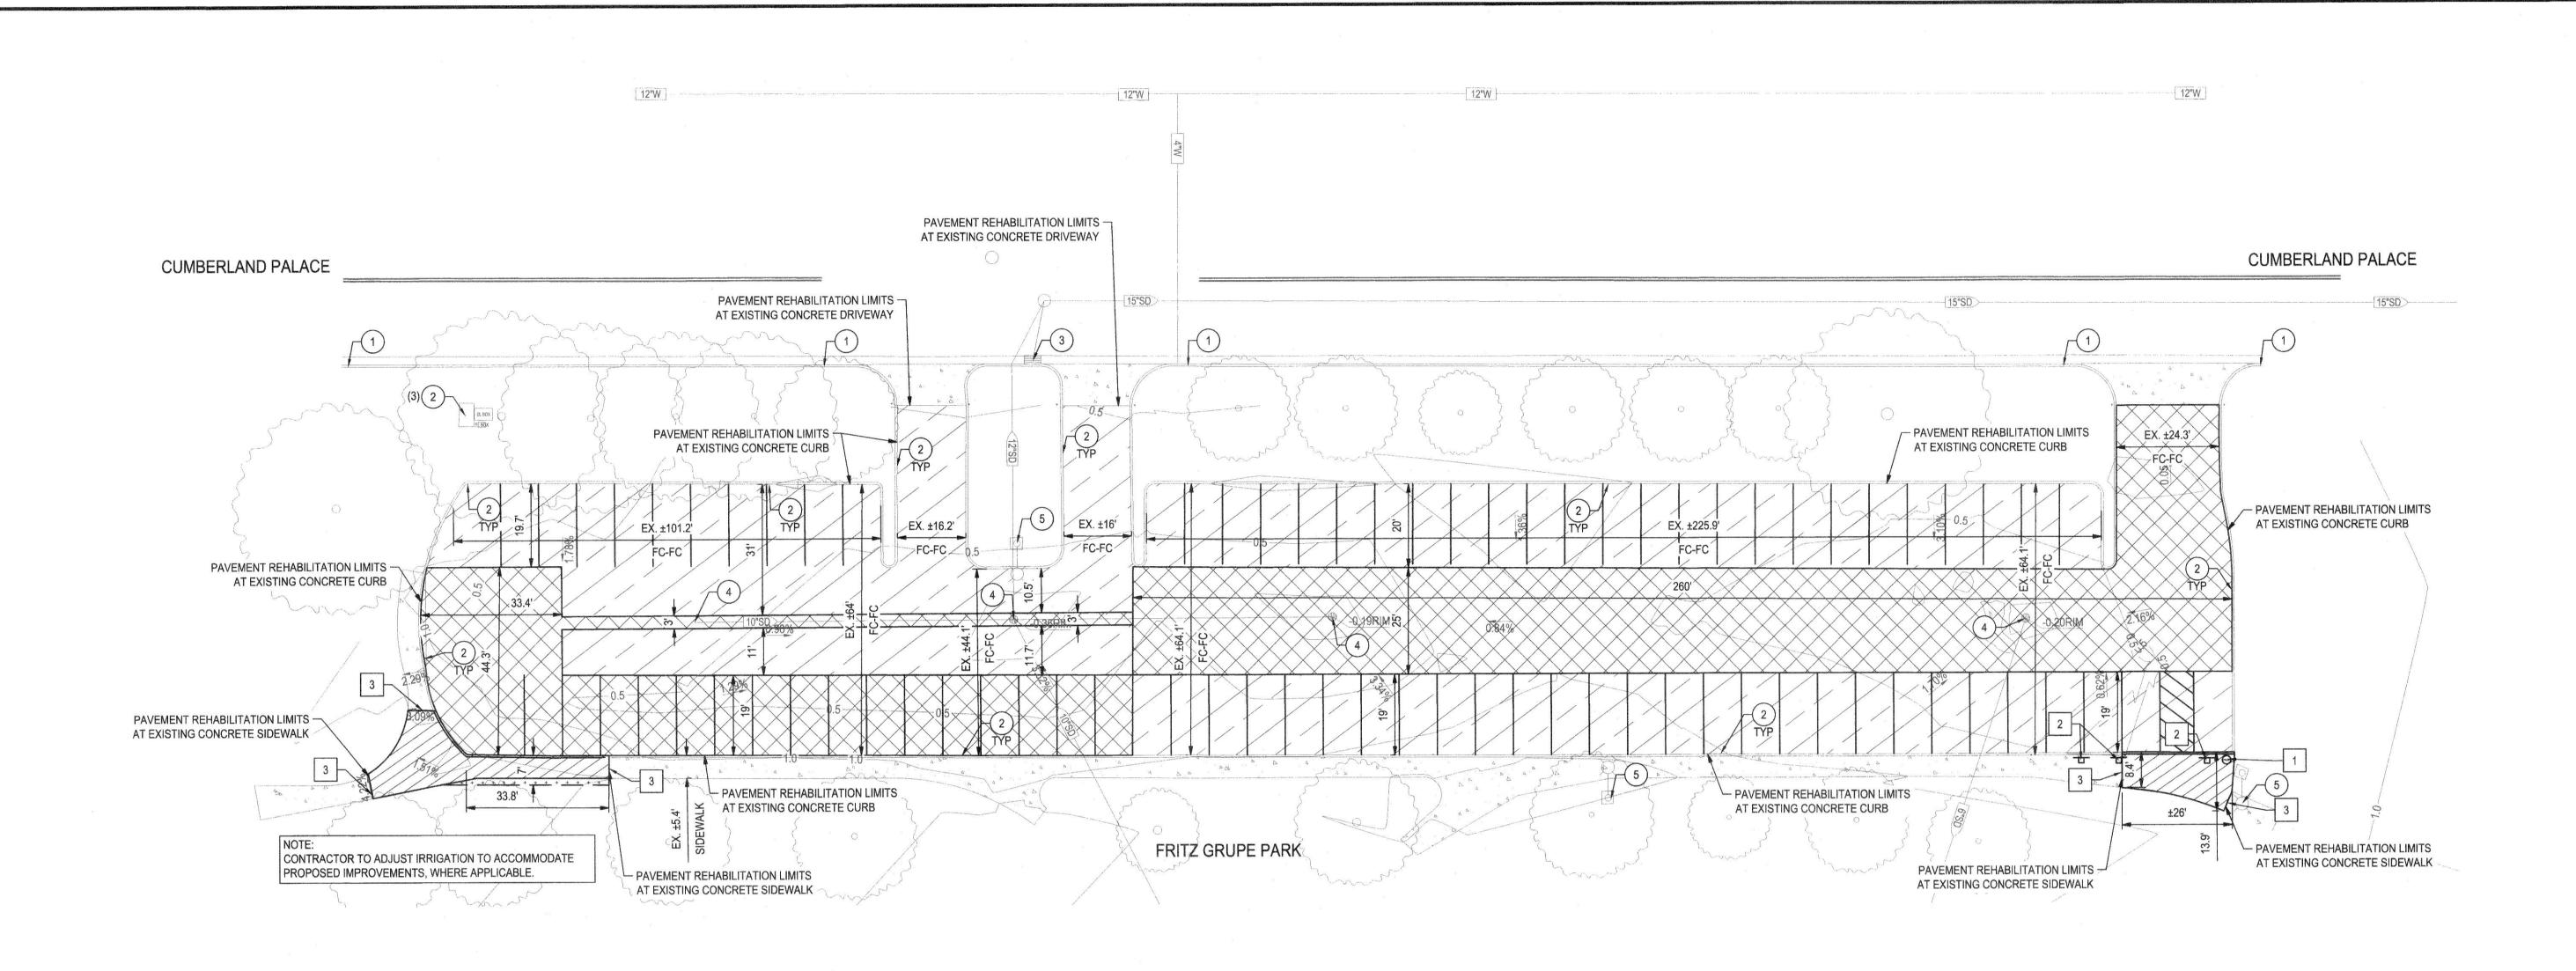- CONTRACTOR IS RESPONSIBLE FOR REMOVING AND PROPERLY DISPOSING OF ALL MATERIALS DEMOLISHED FROM THE SITE INCLUDING: PAVEMENT, CONCRETE, CURB AND GUTTER, STORM DRAINAGE MATERIALS AND ELECTRICAL MATERIALS.
- 2. ANYTHING NOT CALLED OUT TO BE REMOVED SHALL BE PROTECTED IN PLACE, AND IF DAMAGED, SHALL BE REPLACED / REPAIRED AT THE CONTRACTOR'S EXPENSE.
- 3. ALL EXISTING UTILITIES WERE PLOTTED FROM RECORD INFORMATION AND FIELD TOPOGRAPHY. ACTUAL LOCATIONS MAY VARY AND ADDITIONAL CROSSINGS MAY EXIST IN THE FIELD. IT IS IMPERATIVE THAT "U.S.A. LOCATING SERVICES" LOCATE AND MARK EXISTING UTILITIES PRIOR TO THE START OF EXCAVATION.
- 4. THE CONTRACTOR SHALL USE EXTREME CAUTION WHEN EXPOSING EXISTING UTILITY CROSSINGS AND SERVICES.
- LANDSCAPE PROTECTION AND DEMOLITION TO BE PERFORMED BY LANDSCAPE CONTRACTOR(S).
 CONTRACTOR TO COORDINATE EARTH MOVING AND DEMOLITION OPERATIONS WITH LANDSCAPE CONTRACTOR(S).
- 6. BOLD ITEMS TO BE REMOVED UNLESS OTHERWISE NOTED.


REMOVAL KEY NOTES

- REMOVE EXISTING TRASH RECEPTACLE AND REINSTALL AT SAME LOCATION AFTER IMPROVEMENTS.
- REMOVE AND DISPOSE EXISTING ADA SIGNAGE. SALVAGE POST TO REINSTALL ACCESSIBLE PARKING SIGNAGE PER DETAIL 2 ON SHEET 15.
- 3 SAWCUT, A NEAT STRAIGHT LINE AT NEAREST JOINT

PROTECTION KEY NOTES

- 1) APPROXIMATE RIGHT OF WAY / PROPERTY LINE.
- 2 PROTECT IN PLACE EXISTING CURB.
- 3 PROTECT EXISTING ELECTRIC CABINET IN PLACE.
- PROTECT EXISTING STORM DRAIN MANHOLE / INLET IN PLACE.
 CONTRACTOR TO UNCLOG/CLEANOUT ALL STORM DRAIN INLETS.
- (5) PROTECT EXISTING SITE LIGHT.



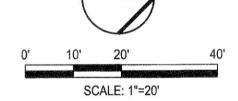



GRUPE PARK PARKING LOT RESURFACING PROJECT NO. WD22011

DATE SIGNED: 11/02/23

DEMOLITION PLAN-CUMBERLAND PL


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SIEGFRIED			ASSESSMENT OF THE PARTY OF THE			SCALE	AS SHOWN	APPROVED BY: 11/16/25	SHEET NO.
3428 Brookside Road CIVIL ENGINEERING						DESIGNED BY	JR	DATE	5
Stockton, CA 95219 Stockton, CA 95219 Phone: 209-943-2021 LANDSCAPE ARCHITECTURE						DRAWN BY	JR //	Su Thouse	OF 15 SHEETS
Fax: 209-942-0214						CHECKED BY	AKM	CITY ENGINEER	WD22011
www.siegfriedeng.com ATHLETIC FACILITY DESIGN						RECORD DWGS.		STOCKTON, CALIFORNIA	PROJECT NO.
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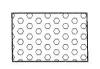


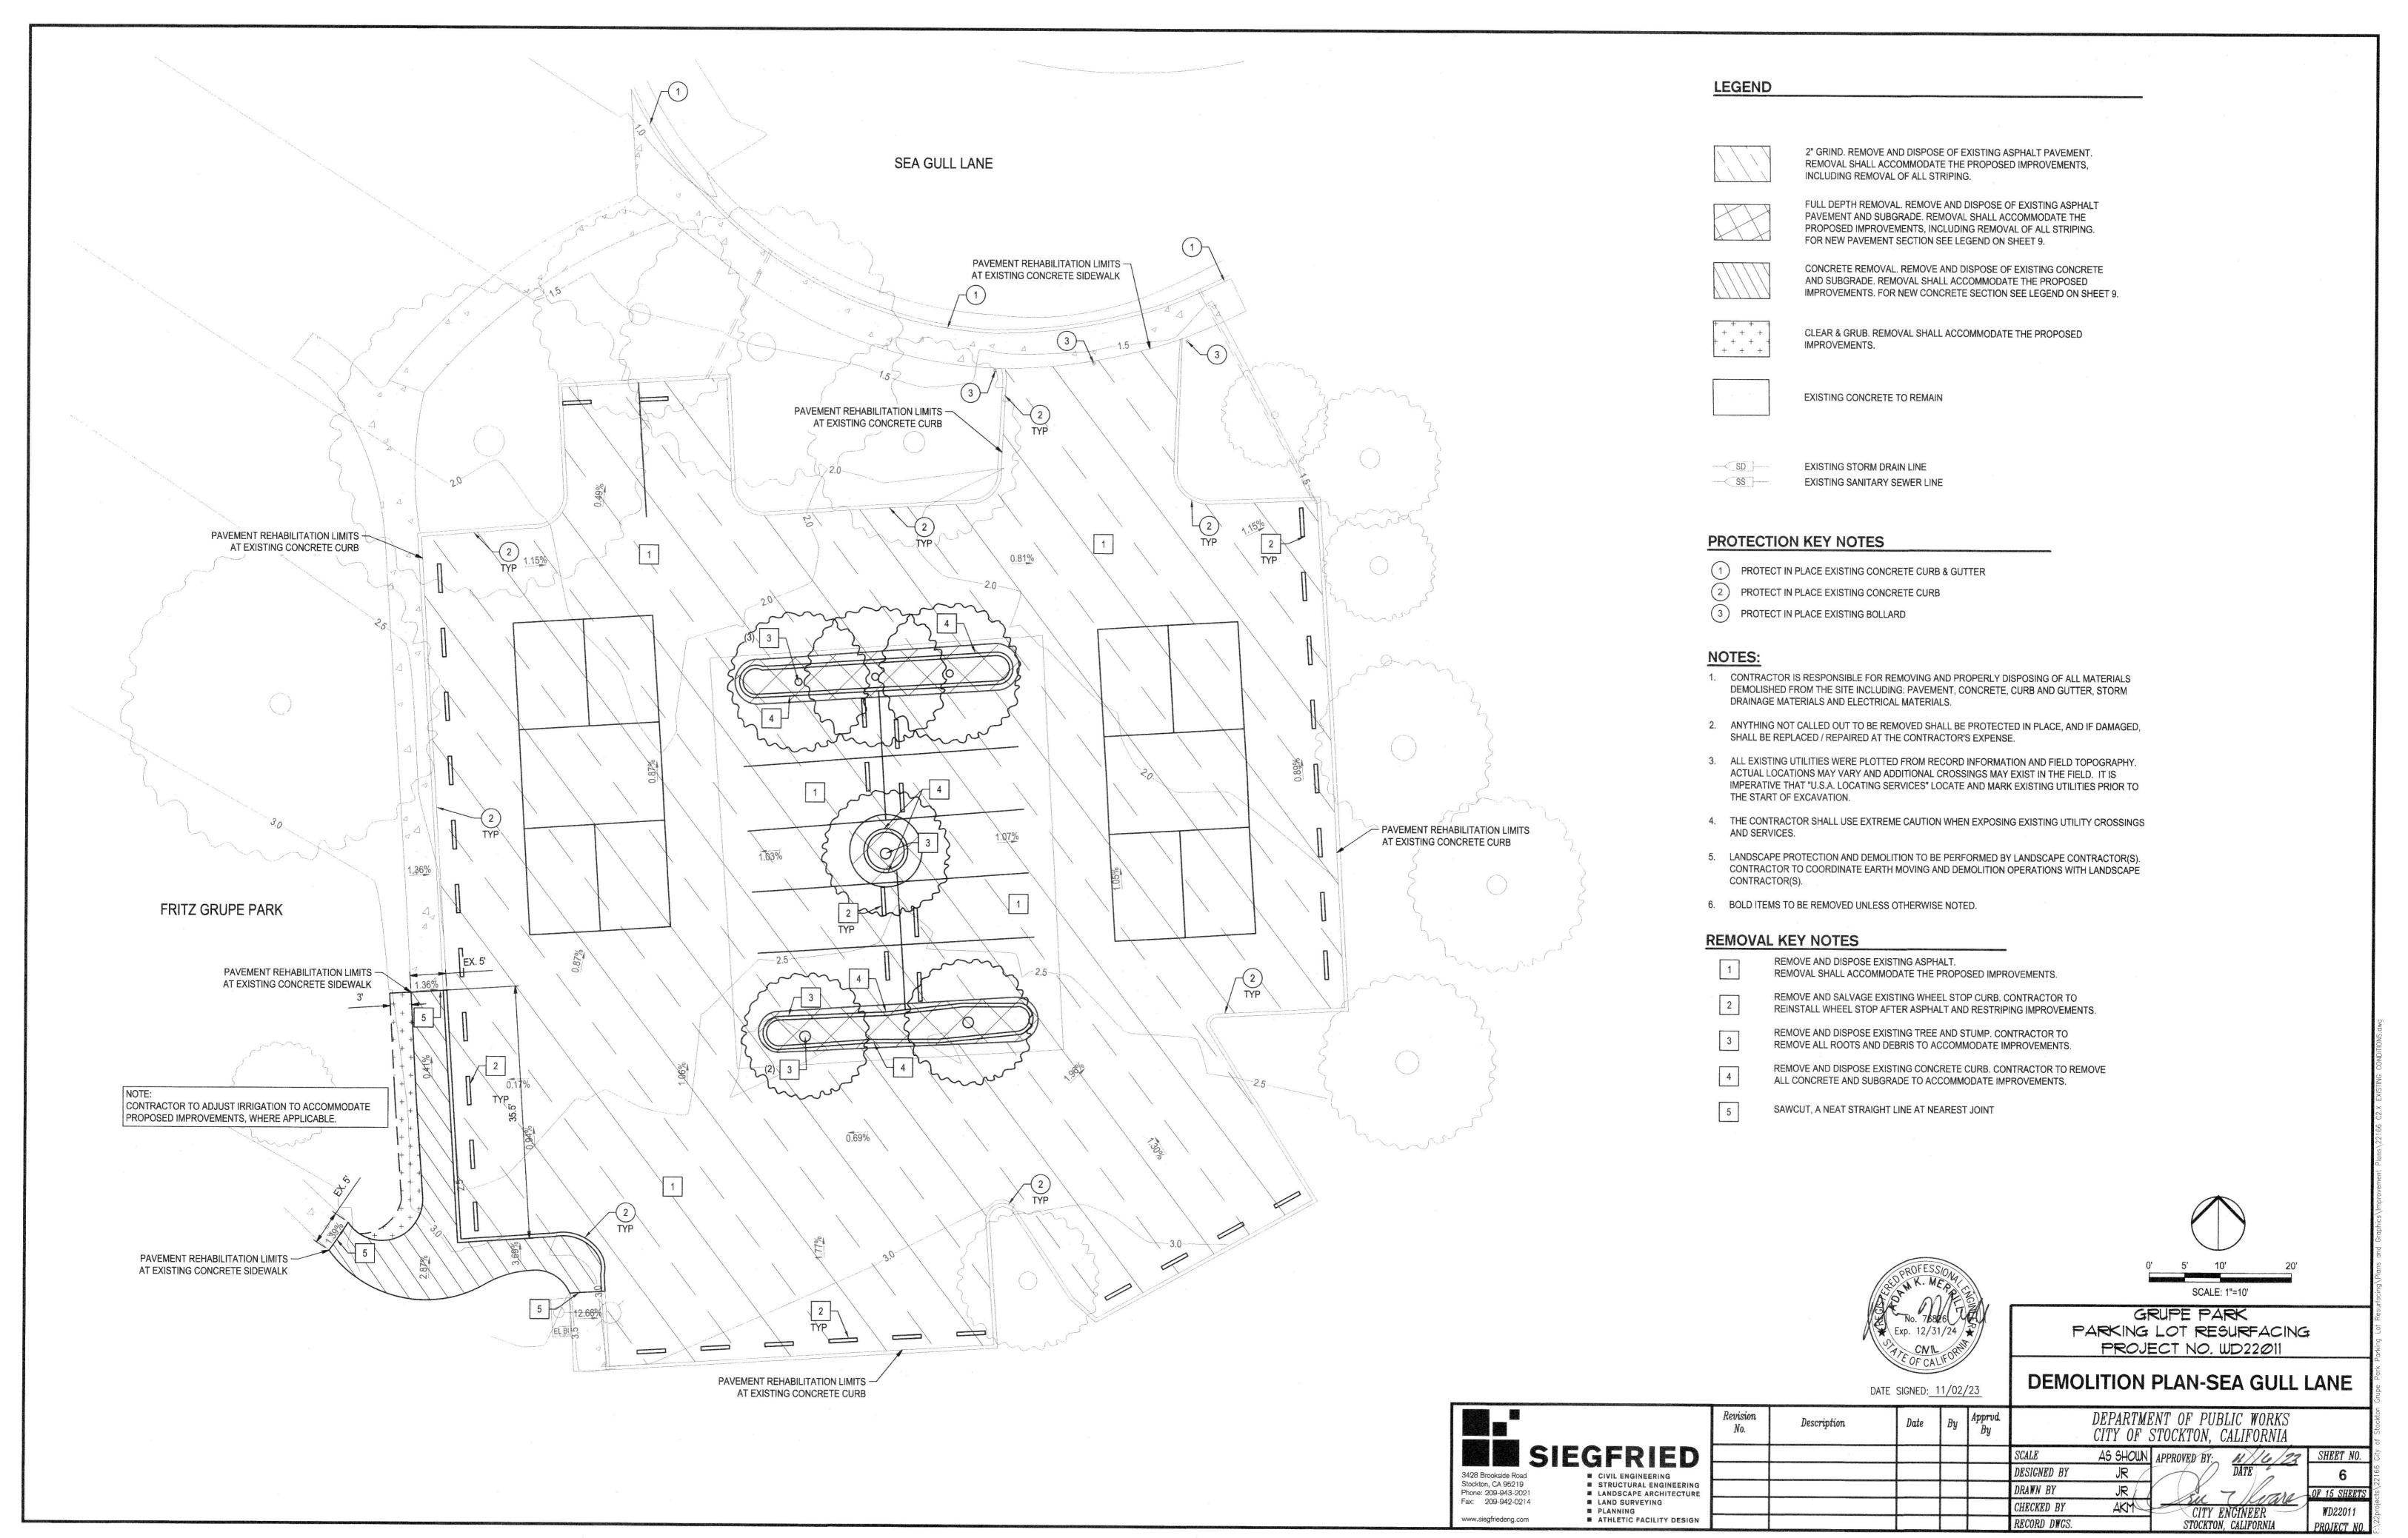LEGEND

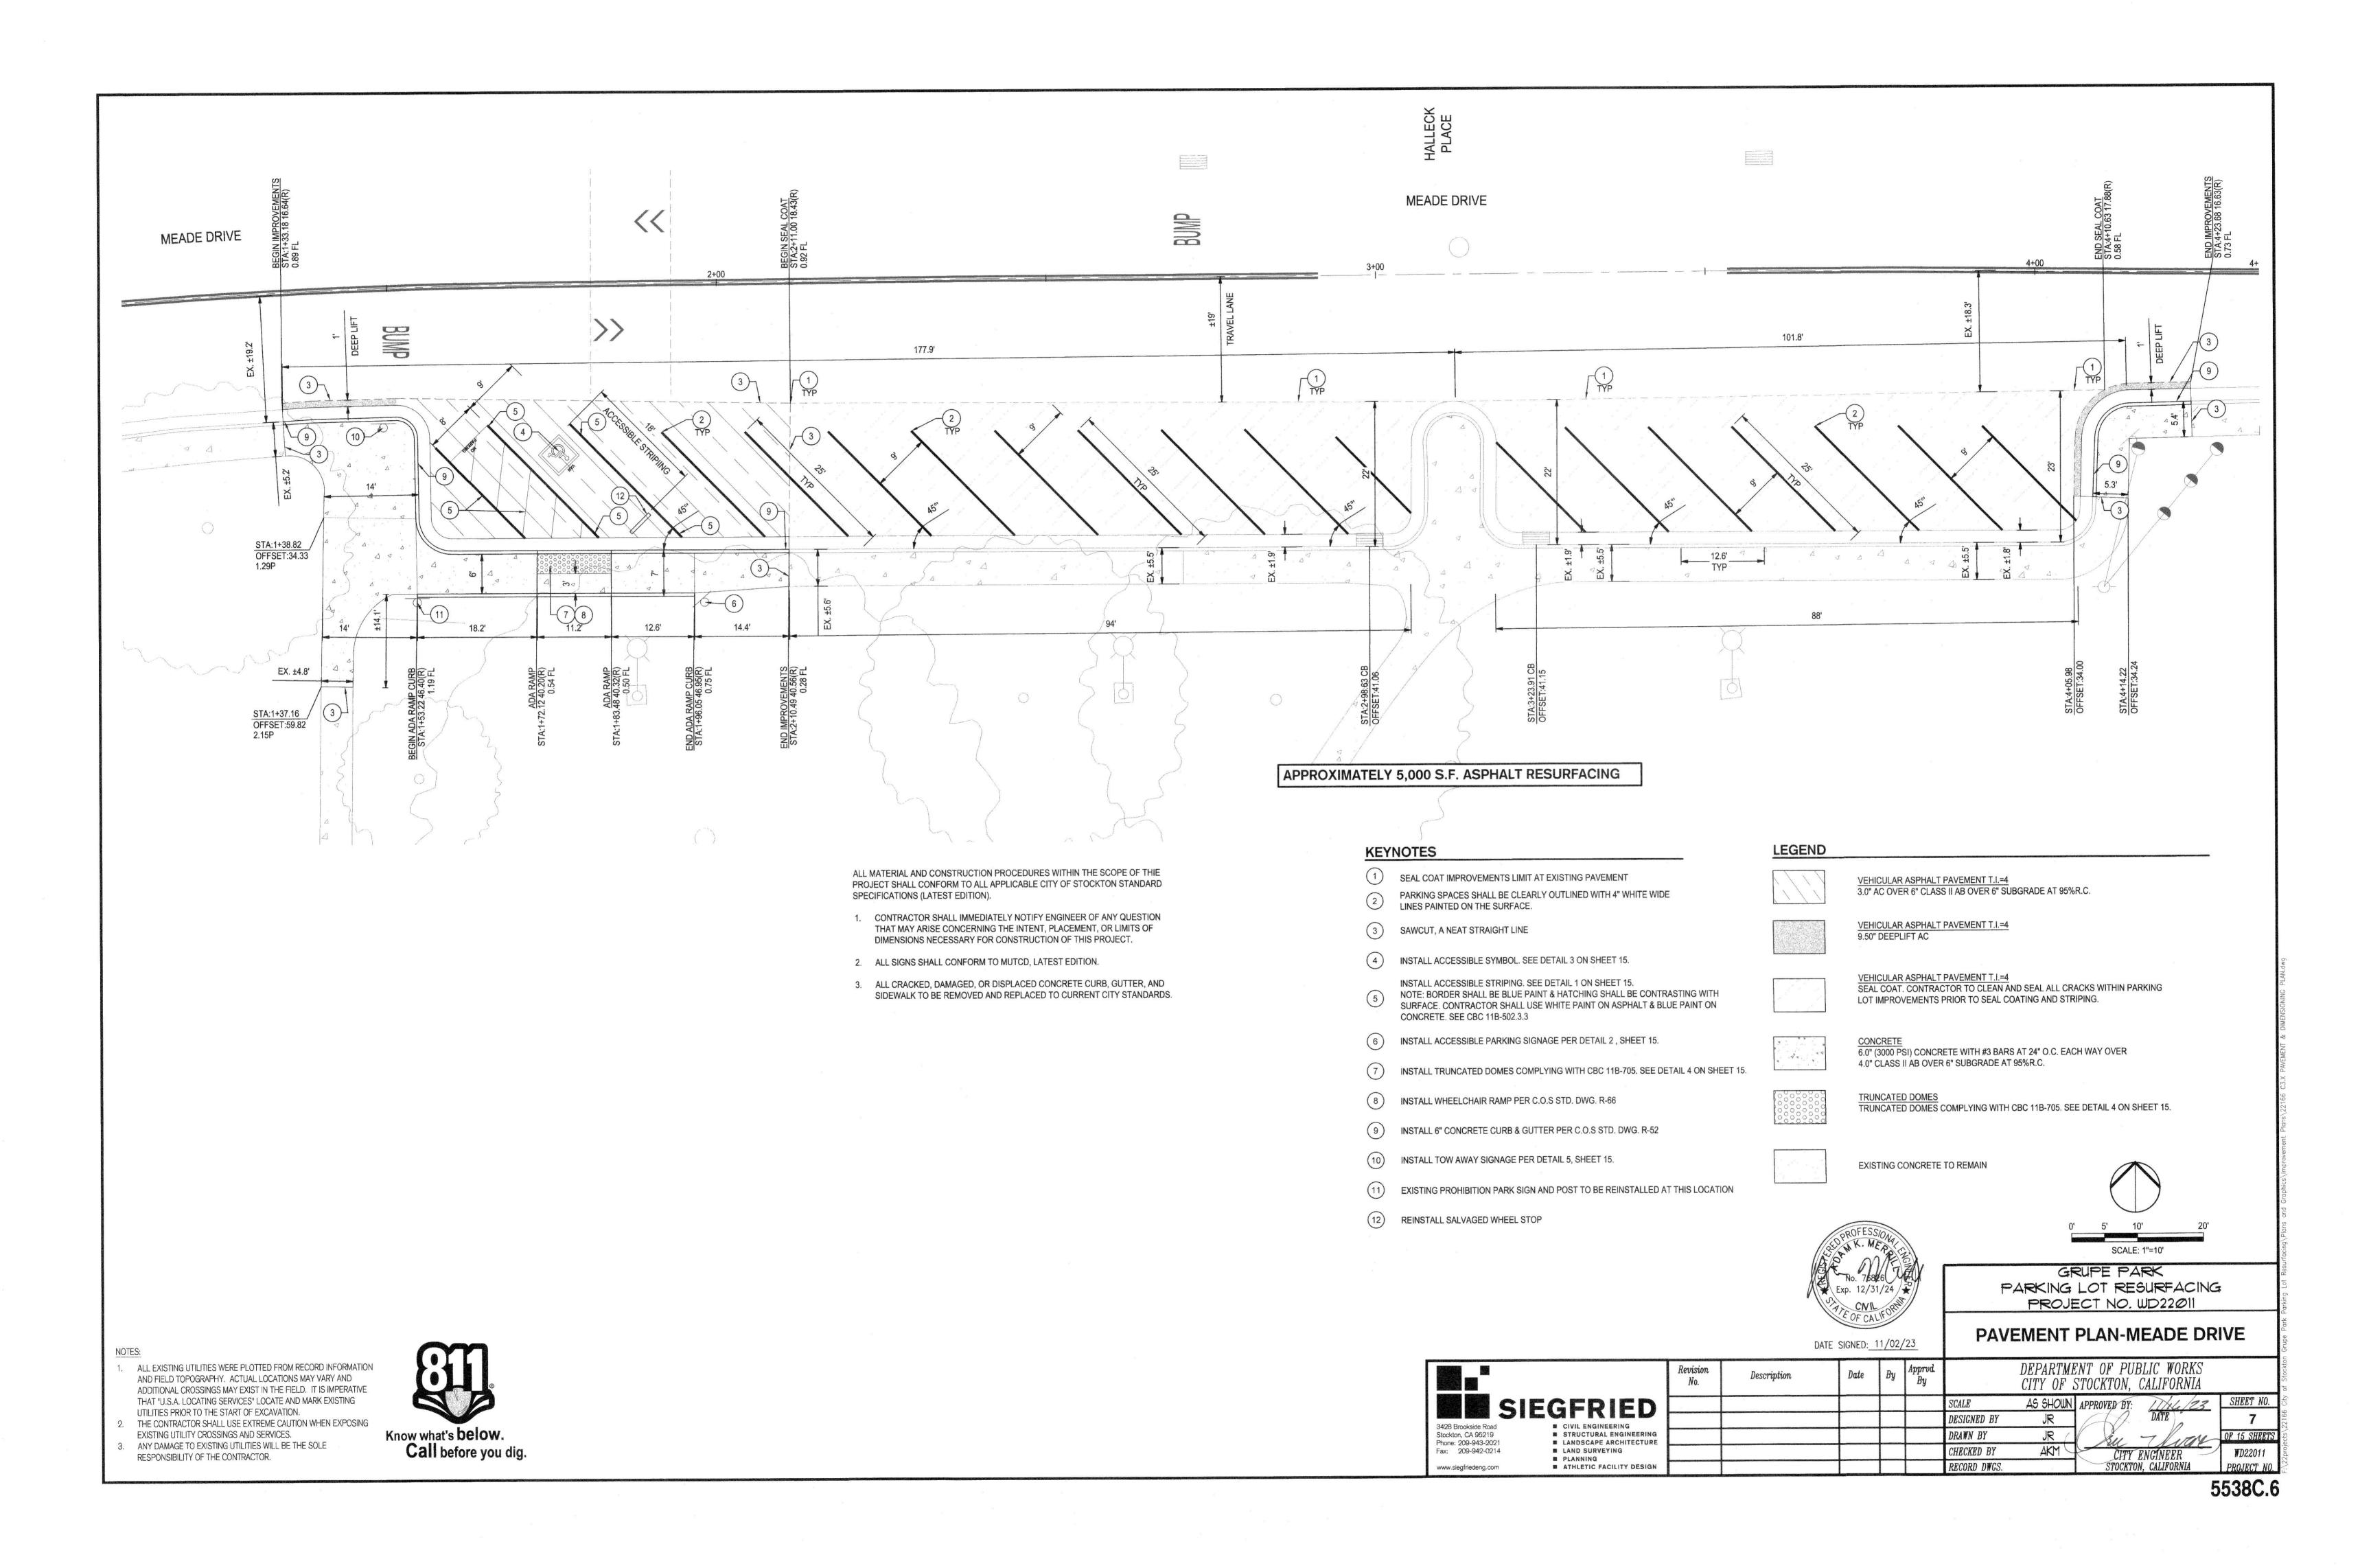
2" HMA INLAY OVER TENSAR GLASPAVE 25 WITH PG GRADE BINDER.

VEHICULAR ASPHALT PAVEMENT T.I.=4 3.0" AC OVER 6" CLASS II AB OVER 6" SUBGRADE AT 95%R.C.

6.0" (3000 PSI) CONCRETE WITH #3 BARS AT 24" O.C. EACH WAY OVER 4.0" CLASS II AB OVER S6" SUBGRADE AT 95%R.C.

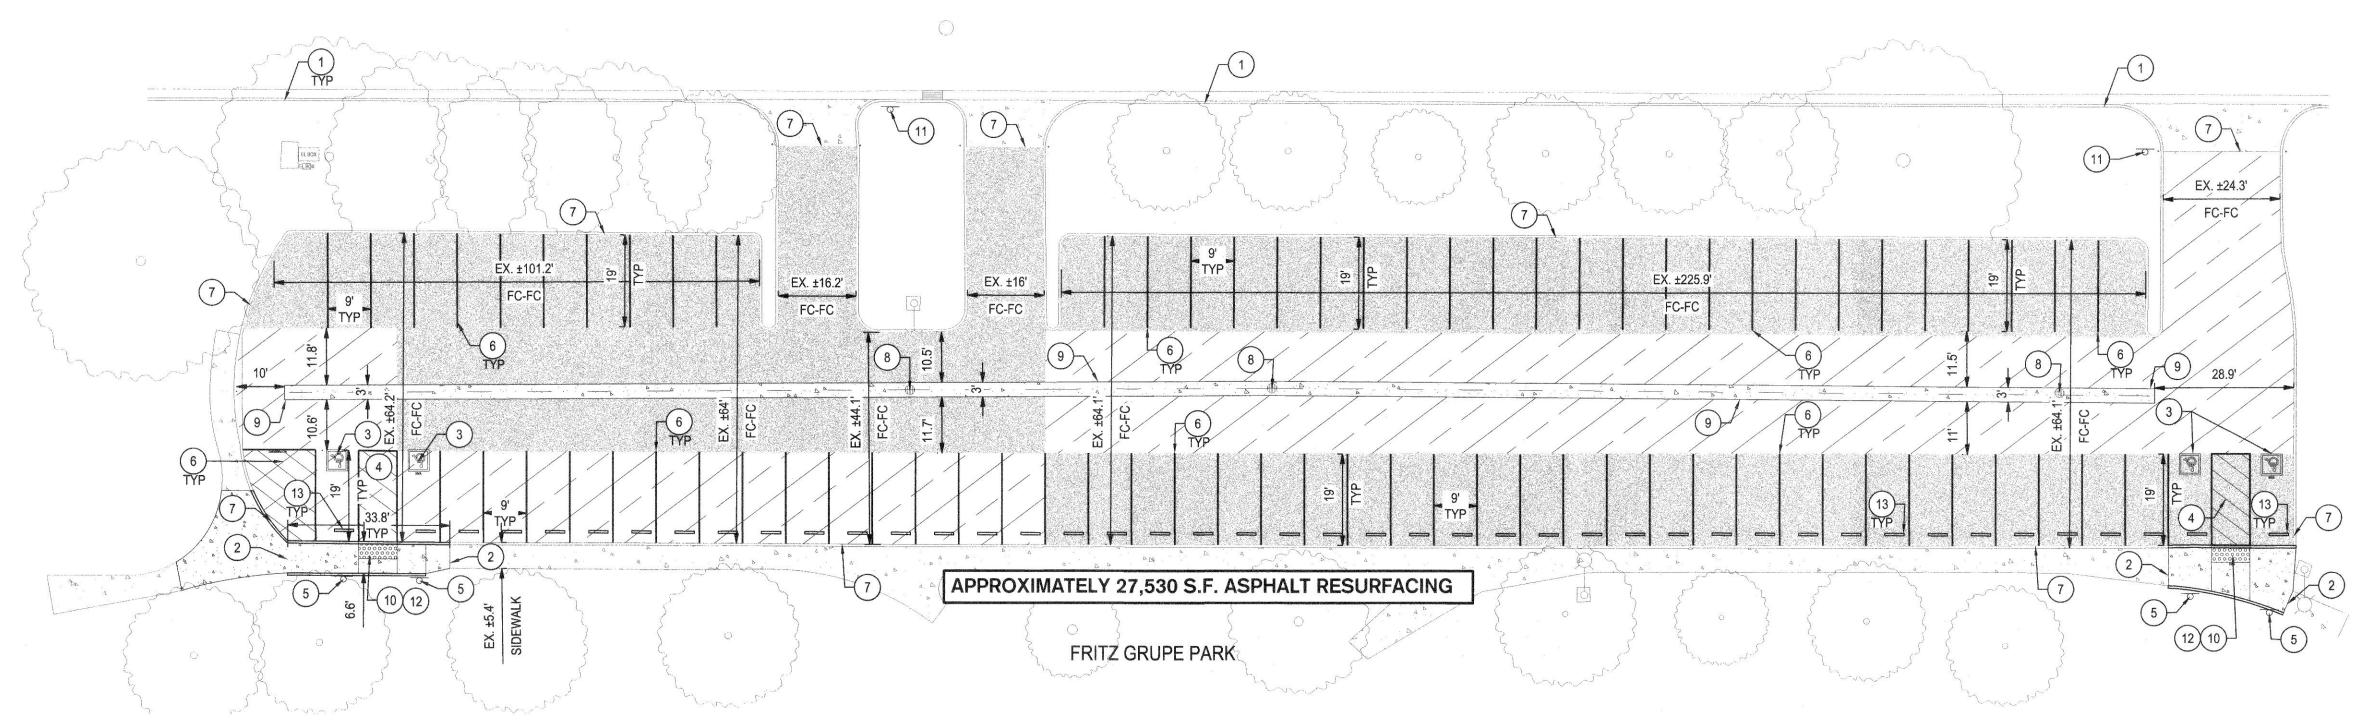

TRUNCATED DOMES COMPLYING WITH CBC 11B-705. SEE DETAIL 4 ON SHEET 15.

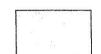

EXISTING CONCRETE TO REMAIN

ALL MATERIAL AND CONSTRUCTION PROCEDURES WITHIN THE SCOPE OF THIE PROJECT SHALL CONFORM TO ALL APPLICABLE CITY OF STOCKTON STANDARD SPECIFICATIONS (LATEST EDITION).

- 1. CONTRACTOR SHALL IMMEDIATELY NOTIFY ENGINEER OF ANY QUESTION THAT MAY ARISE CONCERNING THE INTENT, PLACEMENT, OR LIMITS OF DIMENSIONS NECESSARY FOR CONSTRUCTION OF THIS PROJECT.
- 2. ALL DIMENSIONS ARE TO FACE OF CURB, FACE OF BUILDING, CENTER OF PAINT STRIPING OR PERPENDICULAR TO THE PROPERTY LINE. CONTRACTOR SHALL VERIFY DIMENSIONS MATCH STRUCTURAL AND ARCHITECTURAL PLANS PRIOR TO CONSTRUCTION.
- 3. ALL COORDINATE POINTS ARE AT FACE OF CURB OR RADIUS POINT, BUILDING CONTROL POINTS ARE AT THE OUTER MOST EDGE OF THE BUILDING ENVELOPE. 4. THE CONTRACTOR SHALL SAWCUT EXISTING PAVEMENT, CURBS, AND SIDEWALKS AT NEW PAVEMENT, CURB
- AND SIDEWALK JUNCTURES. NO JAGGED OR IRREGULAR CUTS WILL BE ALLOWED OR ACCEPTED. 5. ALL PAINT SHALL BE 4" WIDE REFLECTIVE PAINT: WHITE ON TOP OF 6" WIDE BLACK STRIPE ON CONCRETE
- 6. ALL PAVEMENT MARKINGS SHALL RECEIVE TWO COATS OF PAINT.
- 7. ALL SIGNS SHALL CONFORM TO MUTCD, LATEST EDITION.

UNLESS OTHERWISE NOTED ON THE DRAWINGS.

- 8. ALL CURBS ARE 6" HIGH UNLESS OTHERWISE NOTED.
- 9. CONTRACTOR TO REFER TO GEOTECHNICAL REPORT FOR CONSTRUCTION JOINT SPACING REQUIREMENTS IN CONCRETE PAVEMENT.
- 10. ALL CRACKED, DAMAGED, OR DISPLACED CONCRETE CURB, GUTTER, AND SIDEWALK TO BE REMOVED AND REPLACED TO CURRENT CITY STANDARDS.

KEYNOTES

- APPROXIMATE RIGHT OF WAY / PROPERTY LINE
- 2 SAWCUT, A NEAT STRAIGHT LINE
- 3 INSTALL ACCESSIBLE SYMBOL. SEE DETAIL 3 ON SHEET 15.
- INSTALL ACCESSIBLE STRIPING. SEE DETAIL 1 ON SHEET 15. NOTE: BORDER SHALL BE BLUE PAINT & HATCHING SHALL BE CONTRASTING WITH SURFACE. CONTRACTOR SHALL USE WHITE PAINT ON ASPHALT & BLUE PAINT ON CONCRETE. SEE CBC 11B-502.3.3
- 5 INSTALL ACCESSIBLE PARKING SIGNAGE PER DETAIL 2, SHEET 15.

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LANDSCAPE ARCHITECTURE

M ATHLETIC FACILITY DESIGN

M LAND SURVEYING

₩ PLANNING

- PARKING SPACES SHALL BE CLEARLY OUTLINED WITH 4" WHITE WIDE LINES PAINTED ON THE SURFACE.
- 7 LIMITS FOR PAVEMENT REHABILITATION IMPROVEMENTS.

- PROTECT EXISTING STORM DRAIN MANHOLE / INLET IN PLACE. CONTRACTOR TO UNCLOG/CLEANOUT ALL STORM DRAIN INLETS.
- INSTALL 3' CONCRETE V-DITCH. SEE DETAIL 8 ON SHEET 15.
- INSTALL TRUNCATED DOMES COMPLYING WITH CBC 11B-705. SEE DETAIL 4 ON SHEET 15.
- INSTALL TOW AWAY SIGNAGE PER DETAIL 5, SHEET 15.
- 12 INSTALL WHEELCHAIR RAMP PER C.O.S STD. DWG. R-66
- (13) REINSTALL SALVAGED WHEEL STOP

SCALE: 1"=20'

STOCKTON, CALIFORNIA

GRUPE PARK PARKING LOT RESURFACING PROJECT NO. WD22011

PAVEMENT PLAN-CUMBERLAND DATE SIGNED: 11/02/23

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pprvd. By			ENT OF PUBLIC WORKS STOCKTON, CALIFORNIA	
	SCALE	AS SHOWN	APPROVED BY: /1/6/23	SHEET NO.
	DESIGNED BY	JR	DATE	8
	DRAWN BY	JR / (/	IN 7 House	OF 15 SHEETS
C (A to both common of parts)	CHECKED BY	AKM (CITY ENGINEER	WD22011
	M .			E .

Revision

Description

. ALL EXISTING UTILITIES WERE PLOTTED FROM RECORD INFORMATION AND FIELD TOPOGRAPHY. ACTUAL LOCATIONS MAY VARY AND ADDITIONAL CROSSINGS MAY EXIST IN THE FIELD. IT IS IMPERATIVE THAT "U.S.A. LOCATING SERVICES" LOCATE AND MARK EXISTING


UTILITIES PRIOR TO THE START OF EXCAVATION. THE CONTRACTOR SHALL USE EXTREME CAUTION WHEN EXPOSING EXISTING UTILITY CROSSINGS AND SERVICES.

ANY DAMAGE TO EXISTING UTILITIES WILL BE THE SOLE RESPONSIBILITY OF THE CONTRACTOR.

NOTES:



PROJECT NO.

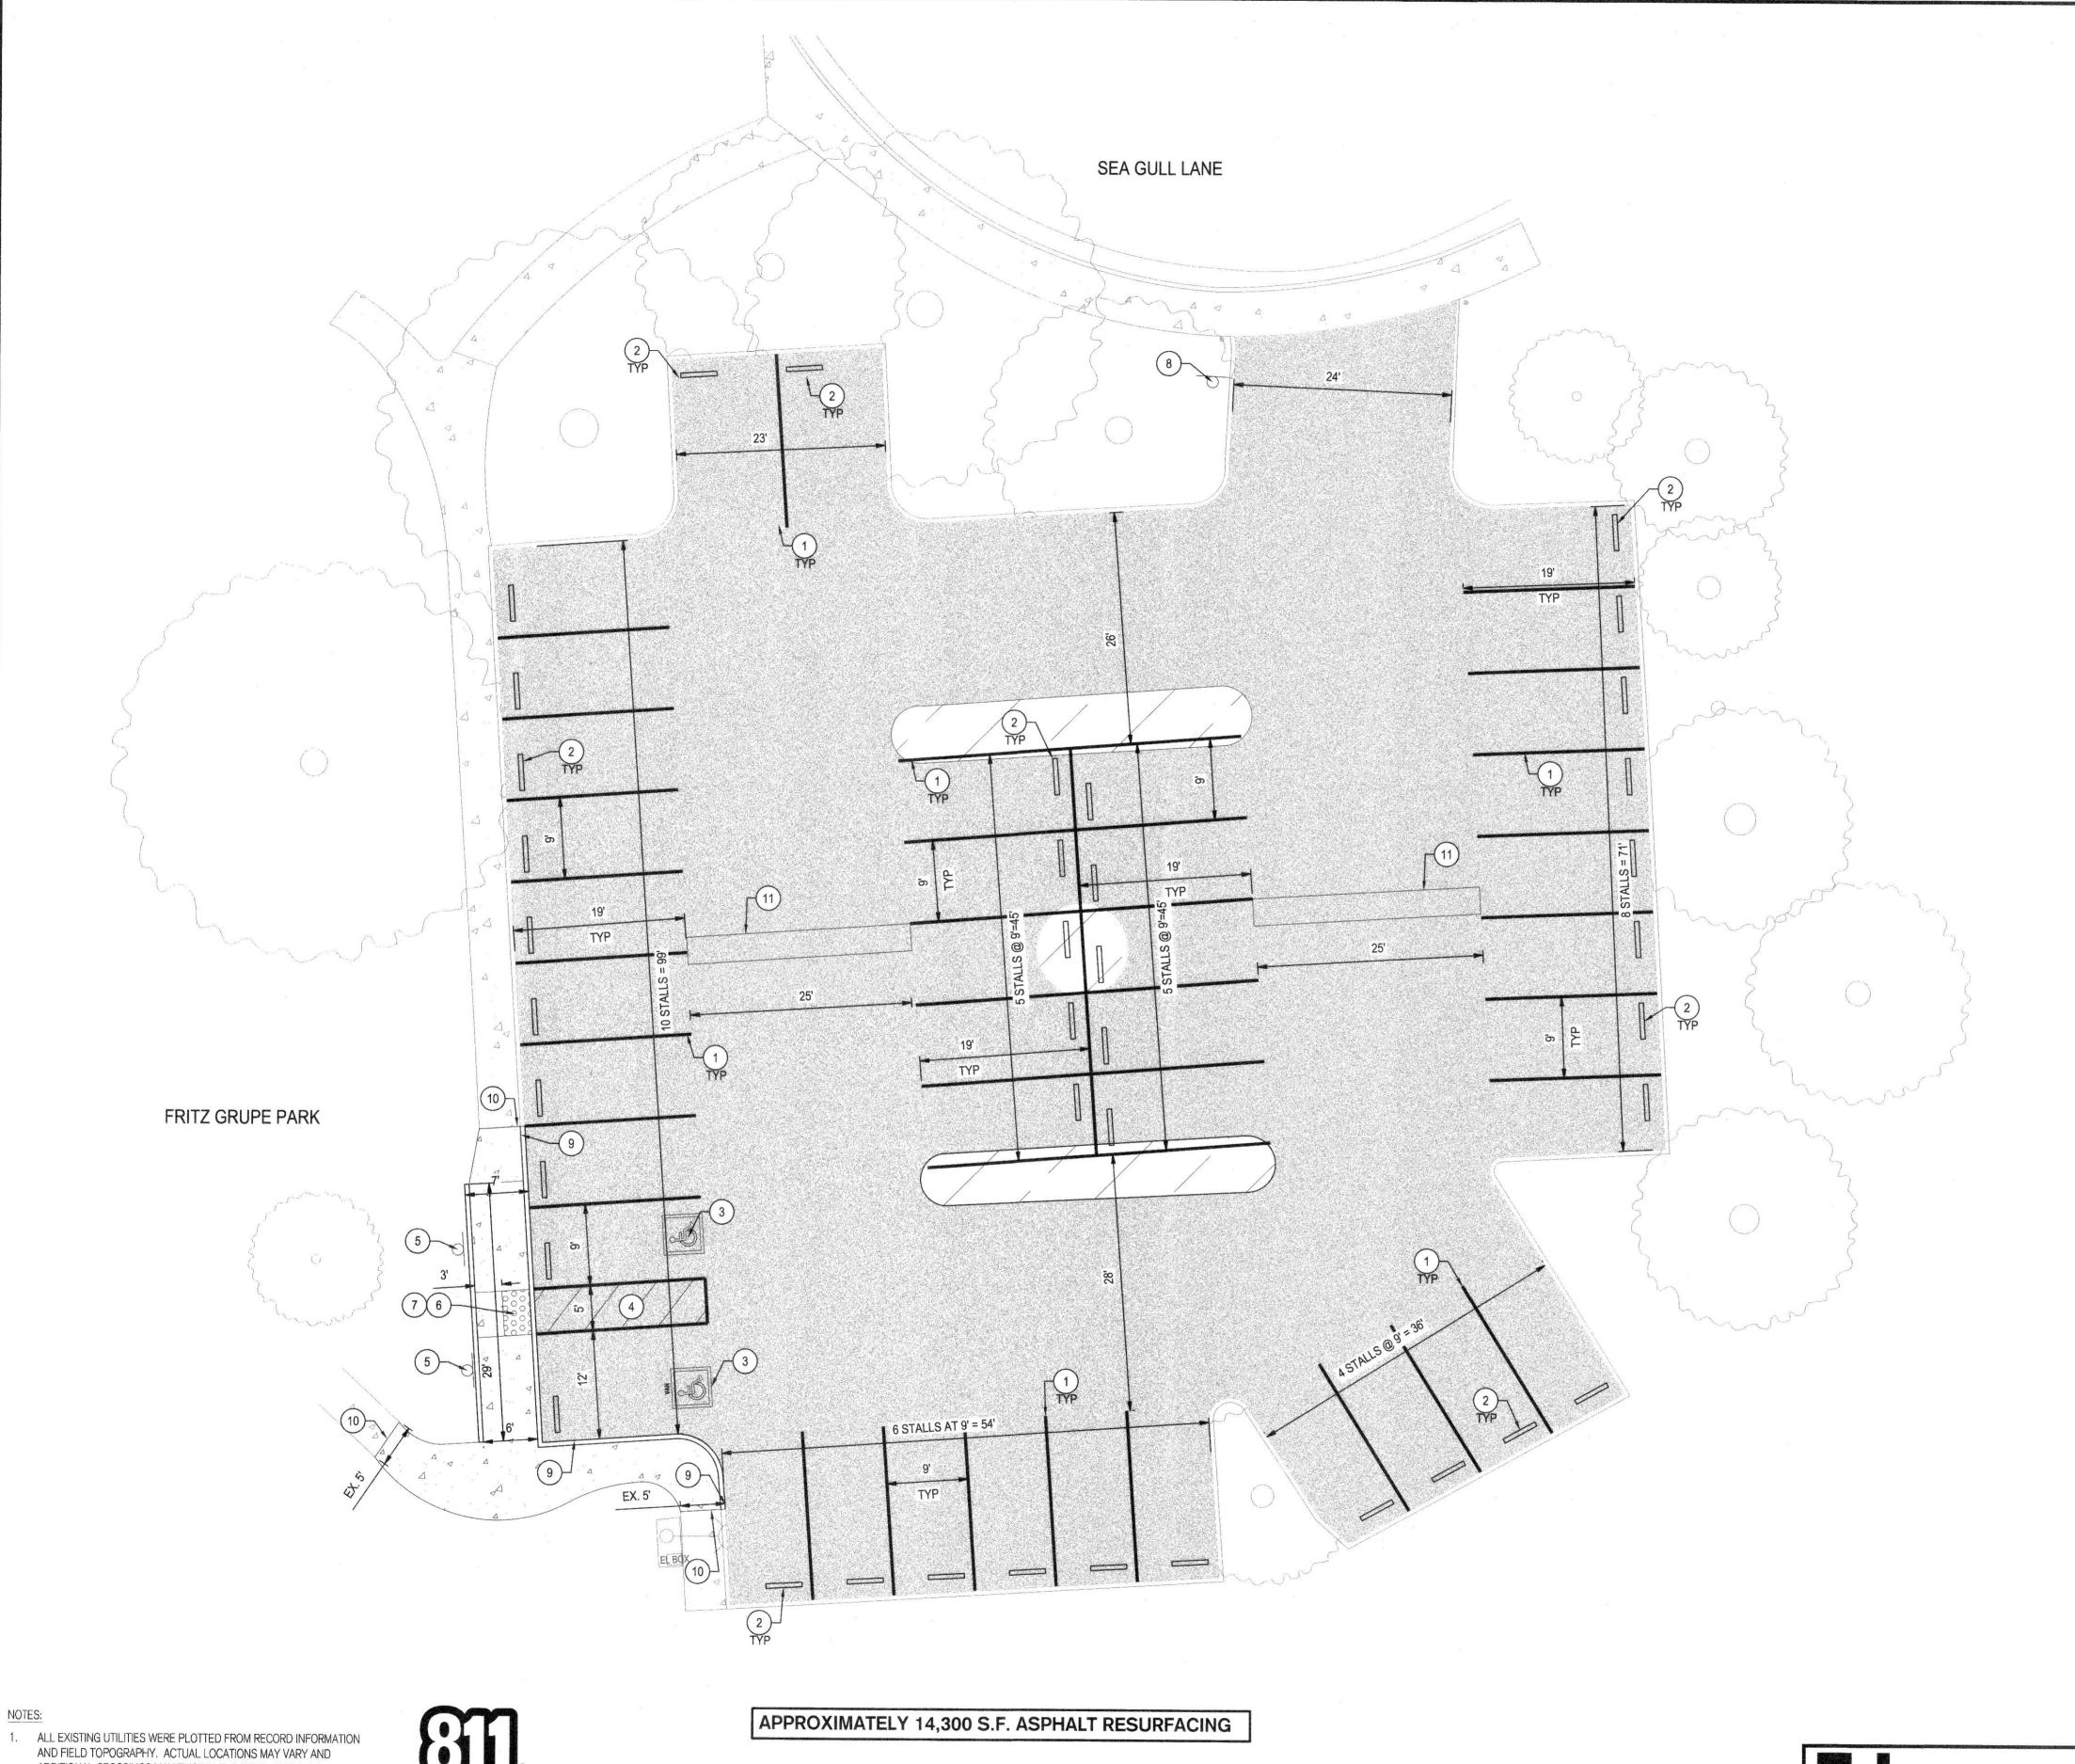

ADDITIONAL CROSSINGS MAY EXIST IN THE FIELD. IT IS IMPERATIVE THAT "U.S.A. LOCATING SERVICES" LOCATE AND MARK EXISTING

THE CONTRACTOR SHALL USE EXTREME CAUTION WHEN EXPOSING

Know what's **below**. **Call** before you dig.

UTILITIES PRIOR TO THE START OF EXCAVATION.

3. ANY DAMAGE TO EXISTING UTILITIES WILL BE THE SOLE

EXISTING UTILITY CROSSINGS AND SERVICES.

RESPONSIBILITY OF THE CONTRACTOR.

LEGEND

VEHICULAR ASPHALT PAVEMENT
2" HMA INLAY OVER TENSAR GLASPAVE 25 WITH PG GRADE BINDER...

6.0" (3000 PSI) CONCRETE WITH #3 BARS AT 24" O.C. EACH WAY OVER 4.0" CLASS II AB OVER 6" SUBGRADE AT 95%R.C.

TRUNCATED DOMES
TRUNCATED DOMES COMPLYING WITH CBC 11B-705. SEE DETAIL 4 ON SHEET 15.




EXISTING CONCRETE TO REMAIN



VEHICULAR ASPHALT PAVEMENT T.I.=4
3.0" AC OVER 6" CLASS II AB OVER 6" SUBGRADE AT 95%R.C.

KEY NOTES


- PARKING SPACES SHALL BE CLEARLY OUTLINED WITH 4" WHITE WIDE LINES PAINTED ON THE SURFACE.
- 2 INSTALL 4' WHEEL STOP. SEE DETAIL 5 ON SHEET 15.
- 3 INSTALL ACCESSIBLE SYMBOL. SEE DETAIL 3 ON SHEET 15.
- INSTALL ACCESSIBLE STRIPING. SEE DETAIL 1 ON SHEET 15. NOTE: BORDER SHALL BE BLUE PAINT & HATCHING SHALL BE CONTRASTING WITH SURFACE. CONTRACTOR SHALL USE WHITE PAINT ON ASPHALT & BLUE PAINT ON CONCRETE. SEE CBC
- 5 INSTALL ACCESSIBLE PARKING SIGNAGE PER DETAIL 2 , SHEET 15.
- 6 INSTALL TRUNCATED DOMES COMPLYING WITH CBC 11B-705. SEE DETAIL 4 ON SHEET 15.
- 7 INSTALL WHEELCHAIR RAMP PER C.O.S STD. DWG. R-66.
- 8 INSTALL TOW AWAY SIGNAGE PER DETAIL 5, SHEET 15.
- 9 INSTALL 6" CONCRETE VERTICAL CURB. SEE DETAIL 8 ON SHEET 15.
- (10) SAWCUT, A NEAT STRAIGHT LINE. SAWCUT AT NEAREST JOINT (TYP).
- (11) INSTALL 3' WIDE RUBBER SPEED HUMP. SEE DETAIL 9 ON SHEET 15.

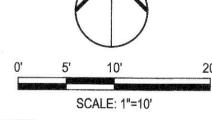



GRUPE PARK PARKING LOT RESURFACING PROJECT NO. WD22011

PAVEMENT PLAN-SEA GULL LANE


DATE SIGNED: 11/02/23 SIEGFRIED DEPARTMENT OF PUBLIC WORKS CITY OF STOCKTON, CALIFORNIA AS SHOWN CIVIL ENGINEERING
STRUCTURAL ENGINEERING
LANDSCAPE ARCHITECTURE
LAND SURVEYING
PLANNING
ATHLETIC FACILITY DESIGN DESIGNED BY JR 3428 Brookside Road Stockton, CA 95219 Phone: 209-943-2021 Fax: 209-942-0214 DRAWN BY CHECKED BY CITY ENGINEER STOCKTON, CALIFORNIA RECORD DWGS.

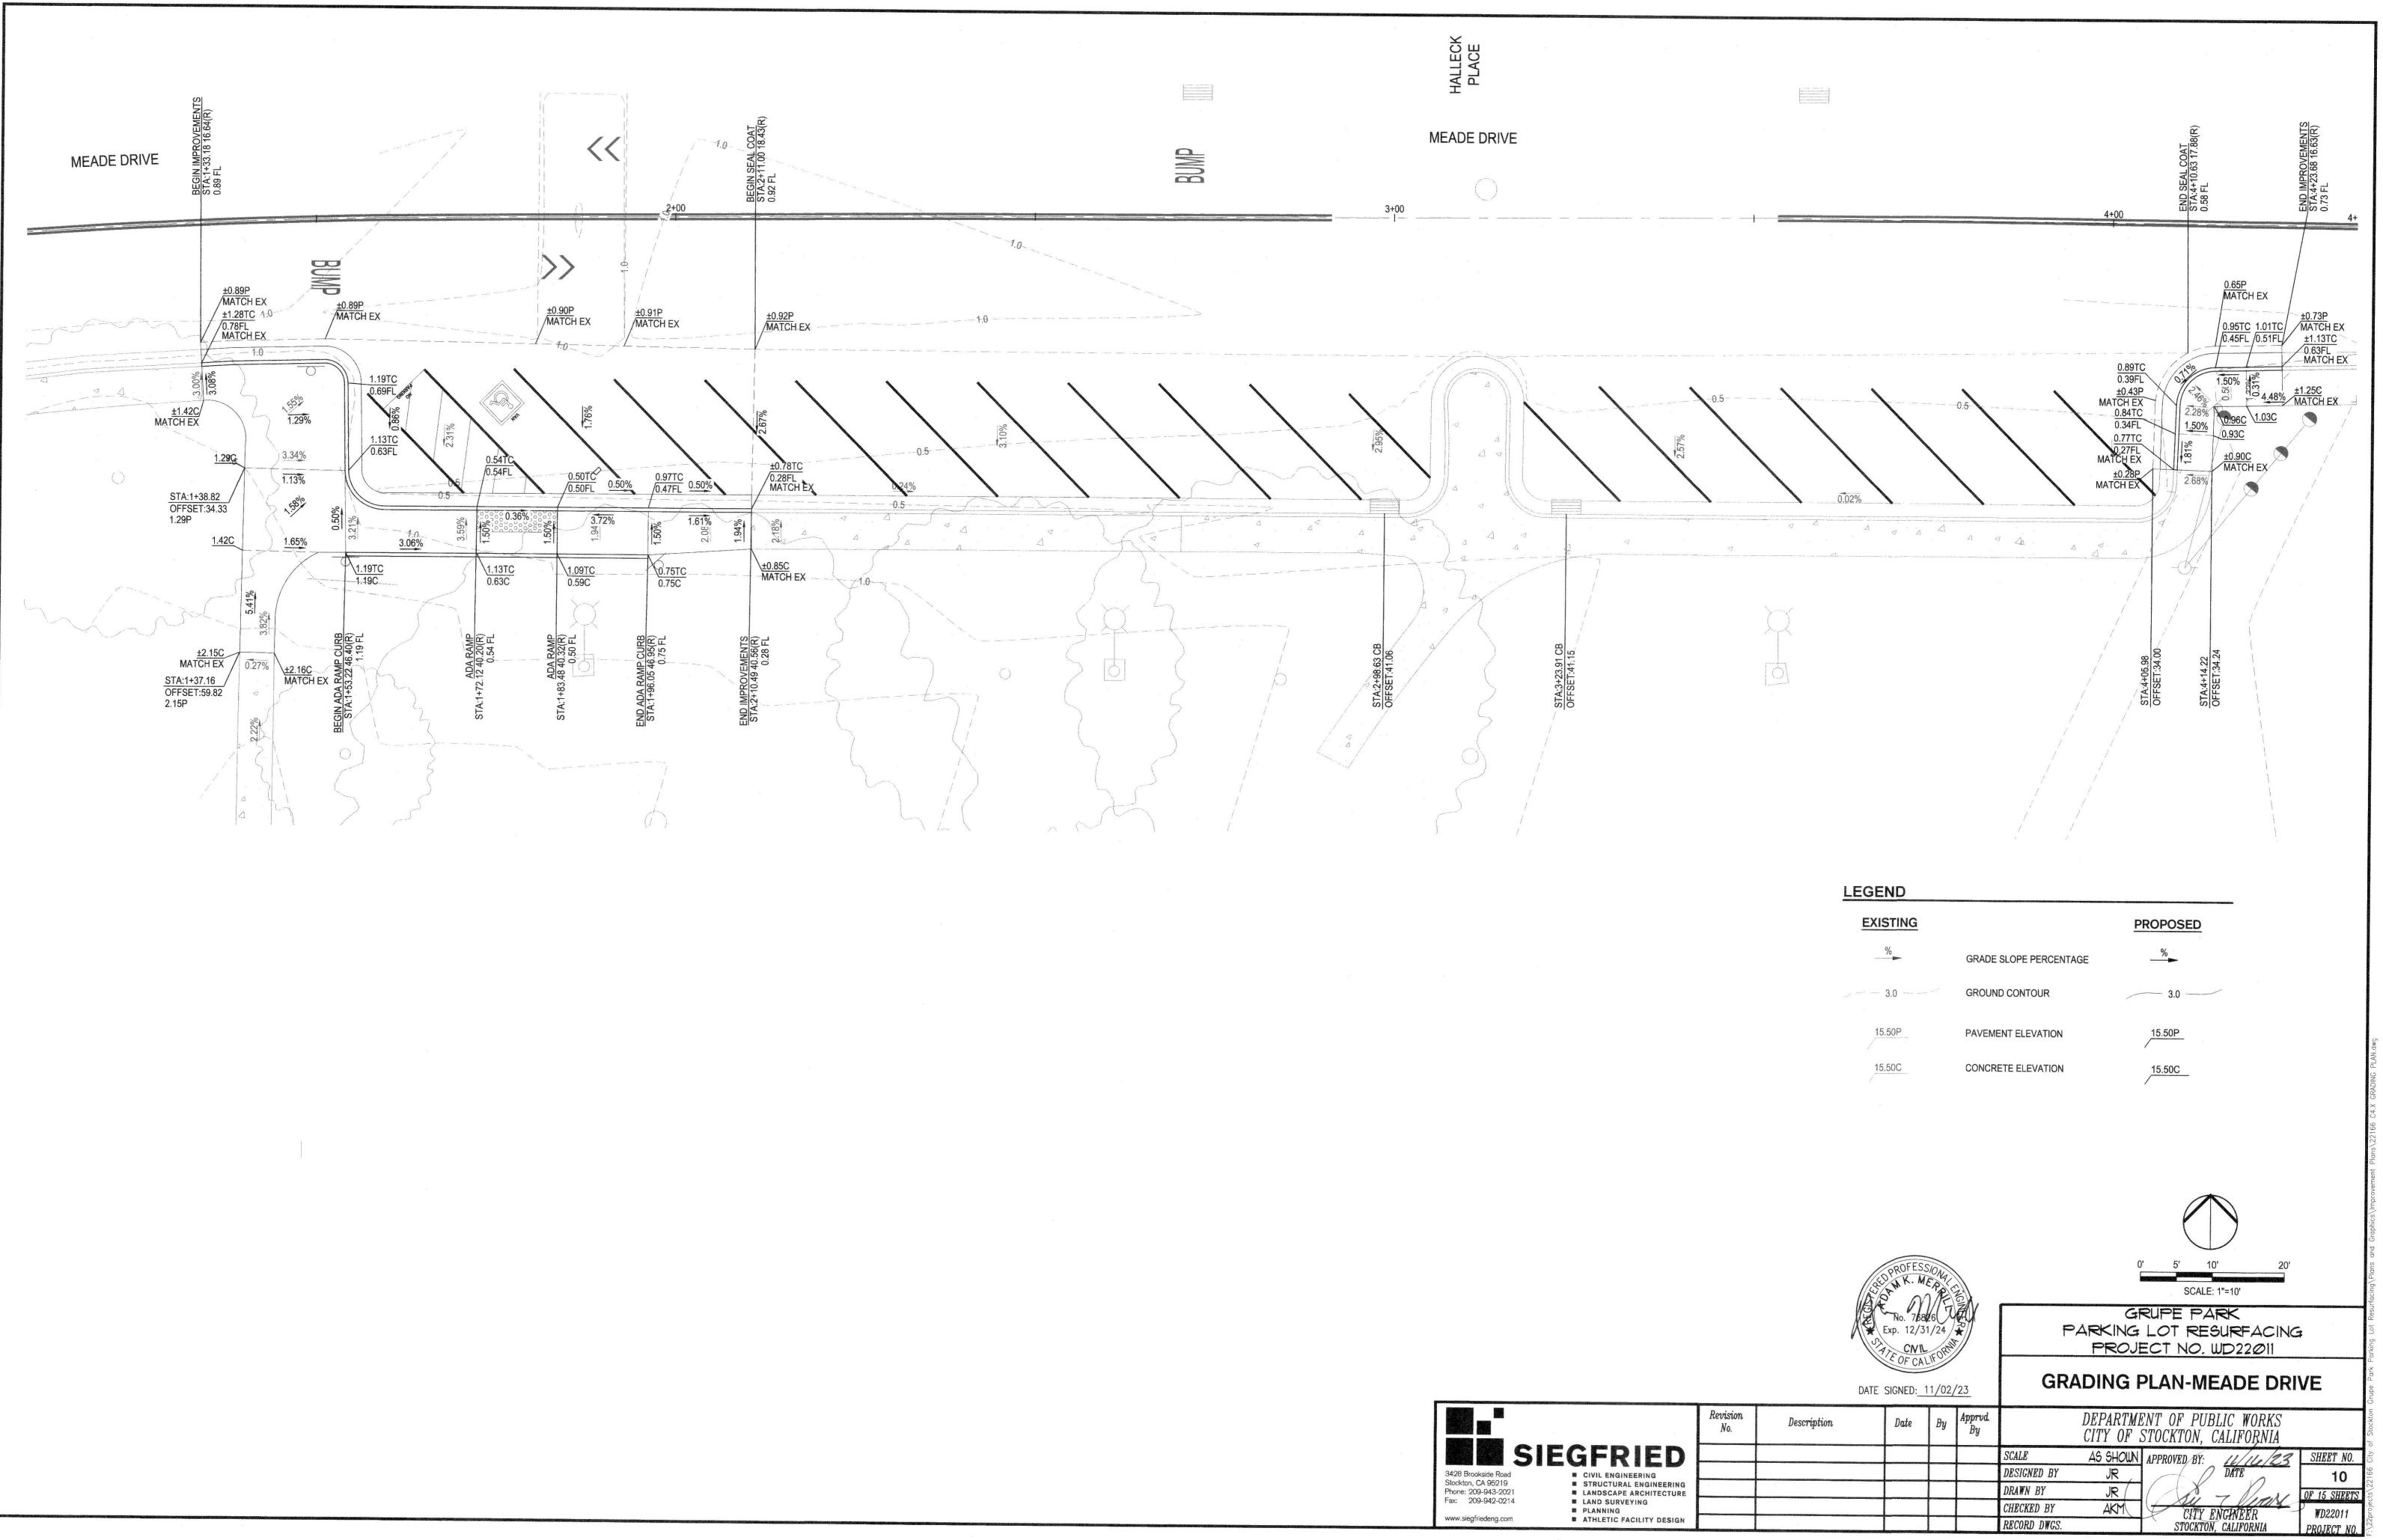


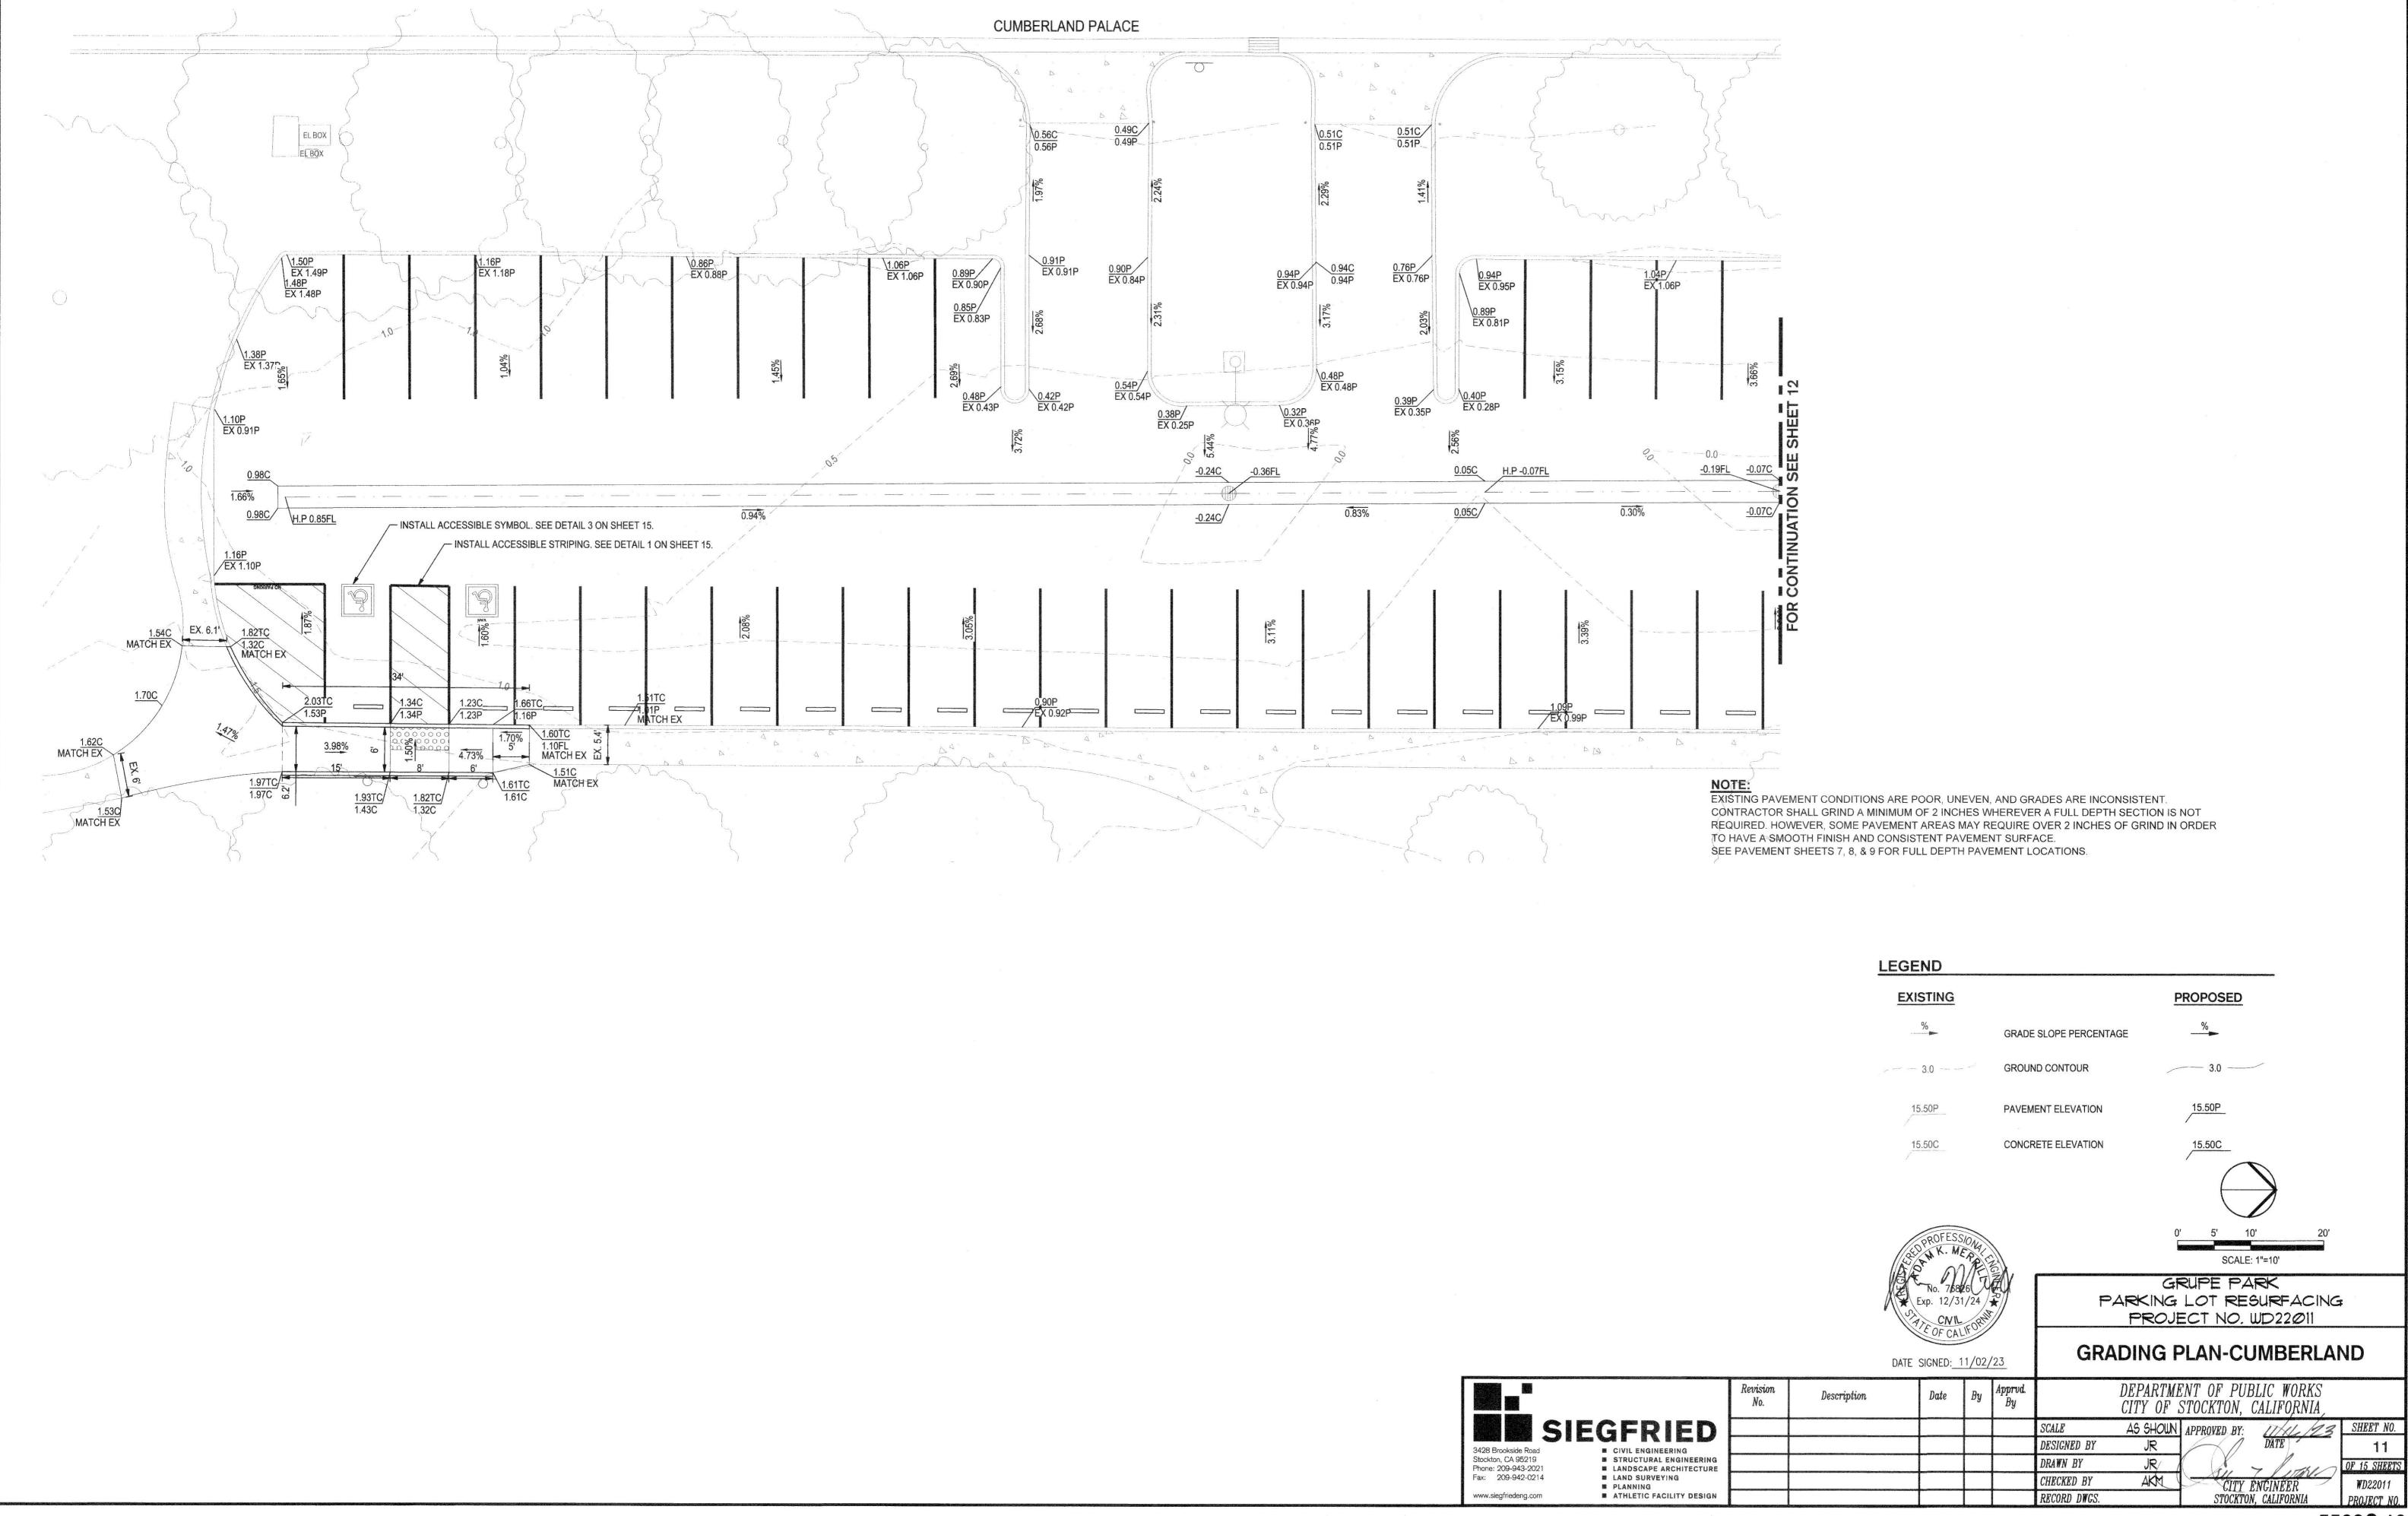

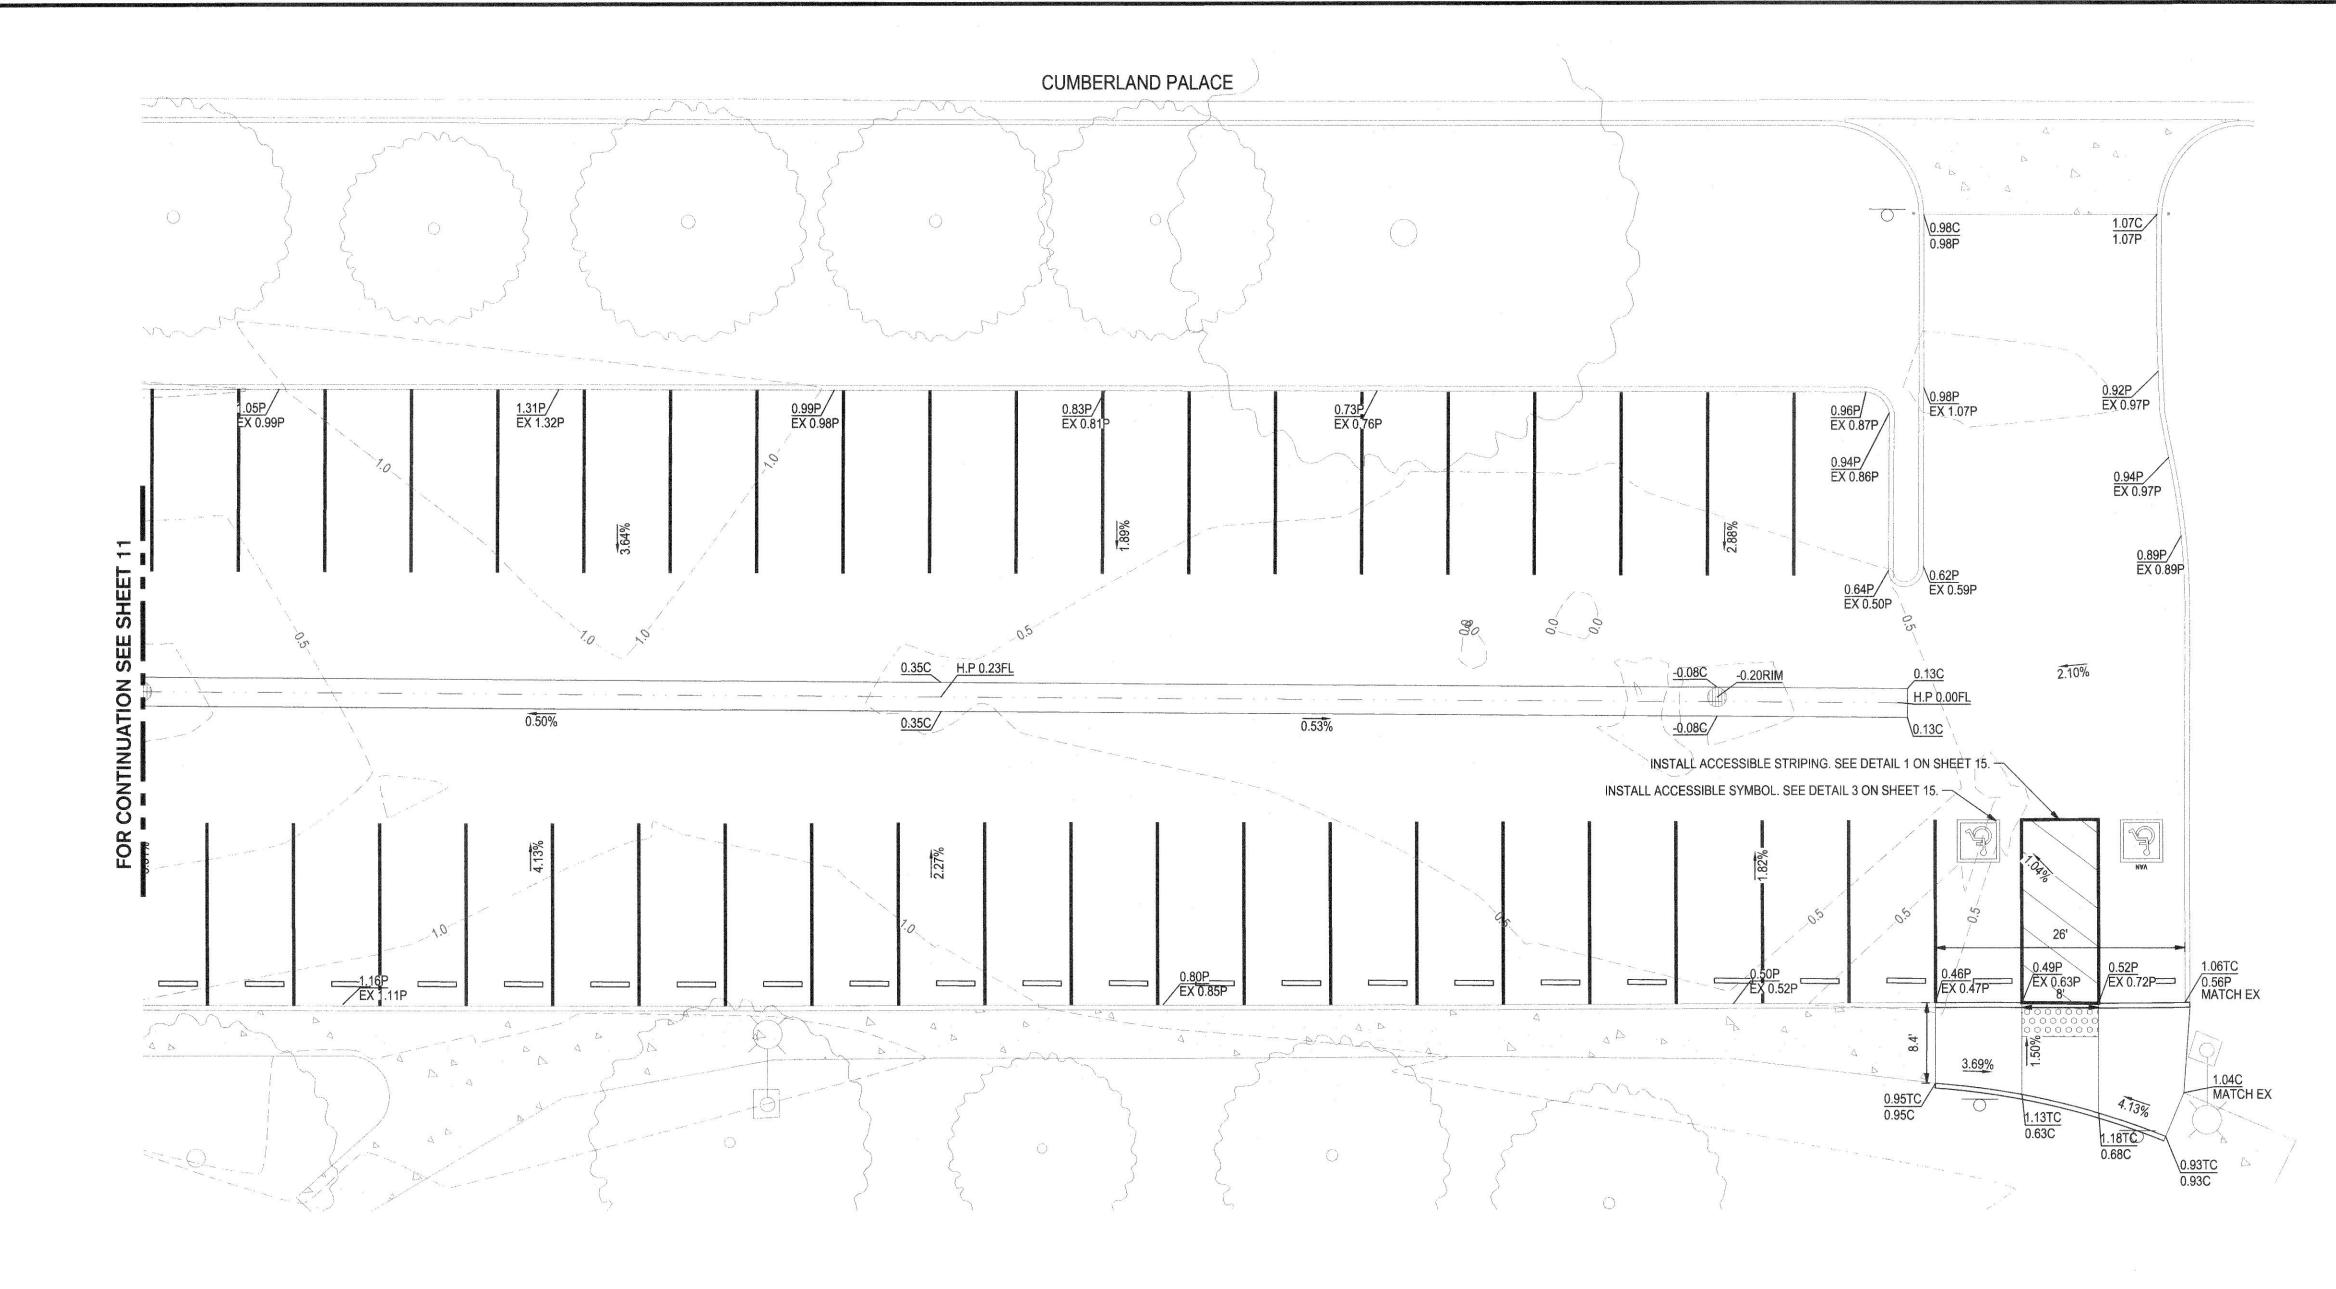

NOTE:
EXISTING PAVEMENT CONDITIONS ARE POOR, UNEVEN, AND GRADES ARE INCONSISTENT.
CONTRACTOR SHALL GRIND A MINIMUM OF 2 INCHES WHEREVER A FULL DEPTH SECTION IS NOT
REQUIRED. HOWEVER, SOME PAVEMENT AREAS MAY REQUIRE OVER 2 INCHES OF GRIND IN ORDER
TO HAVE A SMOOTH FINISH AND CONSISTENT PAVEMENT SURFACE.
SEE PAVEMENT SHEETS 7, 8, & 9 FOR FULL DEPTH PAVEMENT LOCATIONS.

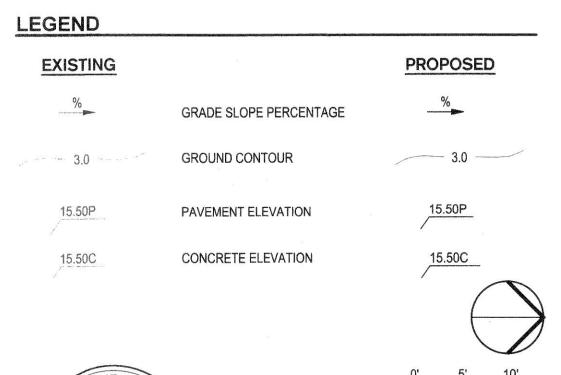


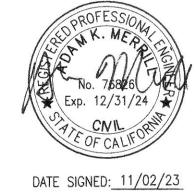


GRUPE PARK PARKING LOT RESURFACING PROJECT NO. WD22011


GRADING PLAN-CUMBERLAND

	Revision No.	Description	Date	Ву	Apprvd. By			ENT OF PUBLIC WORKS STOCKTON, CALIFORNIA	of Stockton
SIEGFRII				and the second second		SCALE DESIGNED BY	AS SHOWN JR	APPROVED BY: 21/26/23	SHEET NO. Alto 9917
3428 Brookside Road Stockton, CA 95219 Phone: 209-943-2021 Fax: 209-942-0214 ■ CIVIL ENGINEERIN STRUCTURAL ENG LANDSCAPE ARCH LAND SURVEYING	SINEERING HITECTURE		· · · · · · · · · · · · · · · · · · ·		Din	DRAWN BY CHECKED BY	JR AKM	XU STUV	OF 15 SHEETS (S)
www.siegfriedeng.com ## ATHLETIC FACILIT	TY DESIGN			The All Styles		RECORD DWGS.	ANI	CITY ENGINEER STOCKTON, CALIFORNIA	WD22011 887 PROJECT NO. 887 887

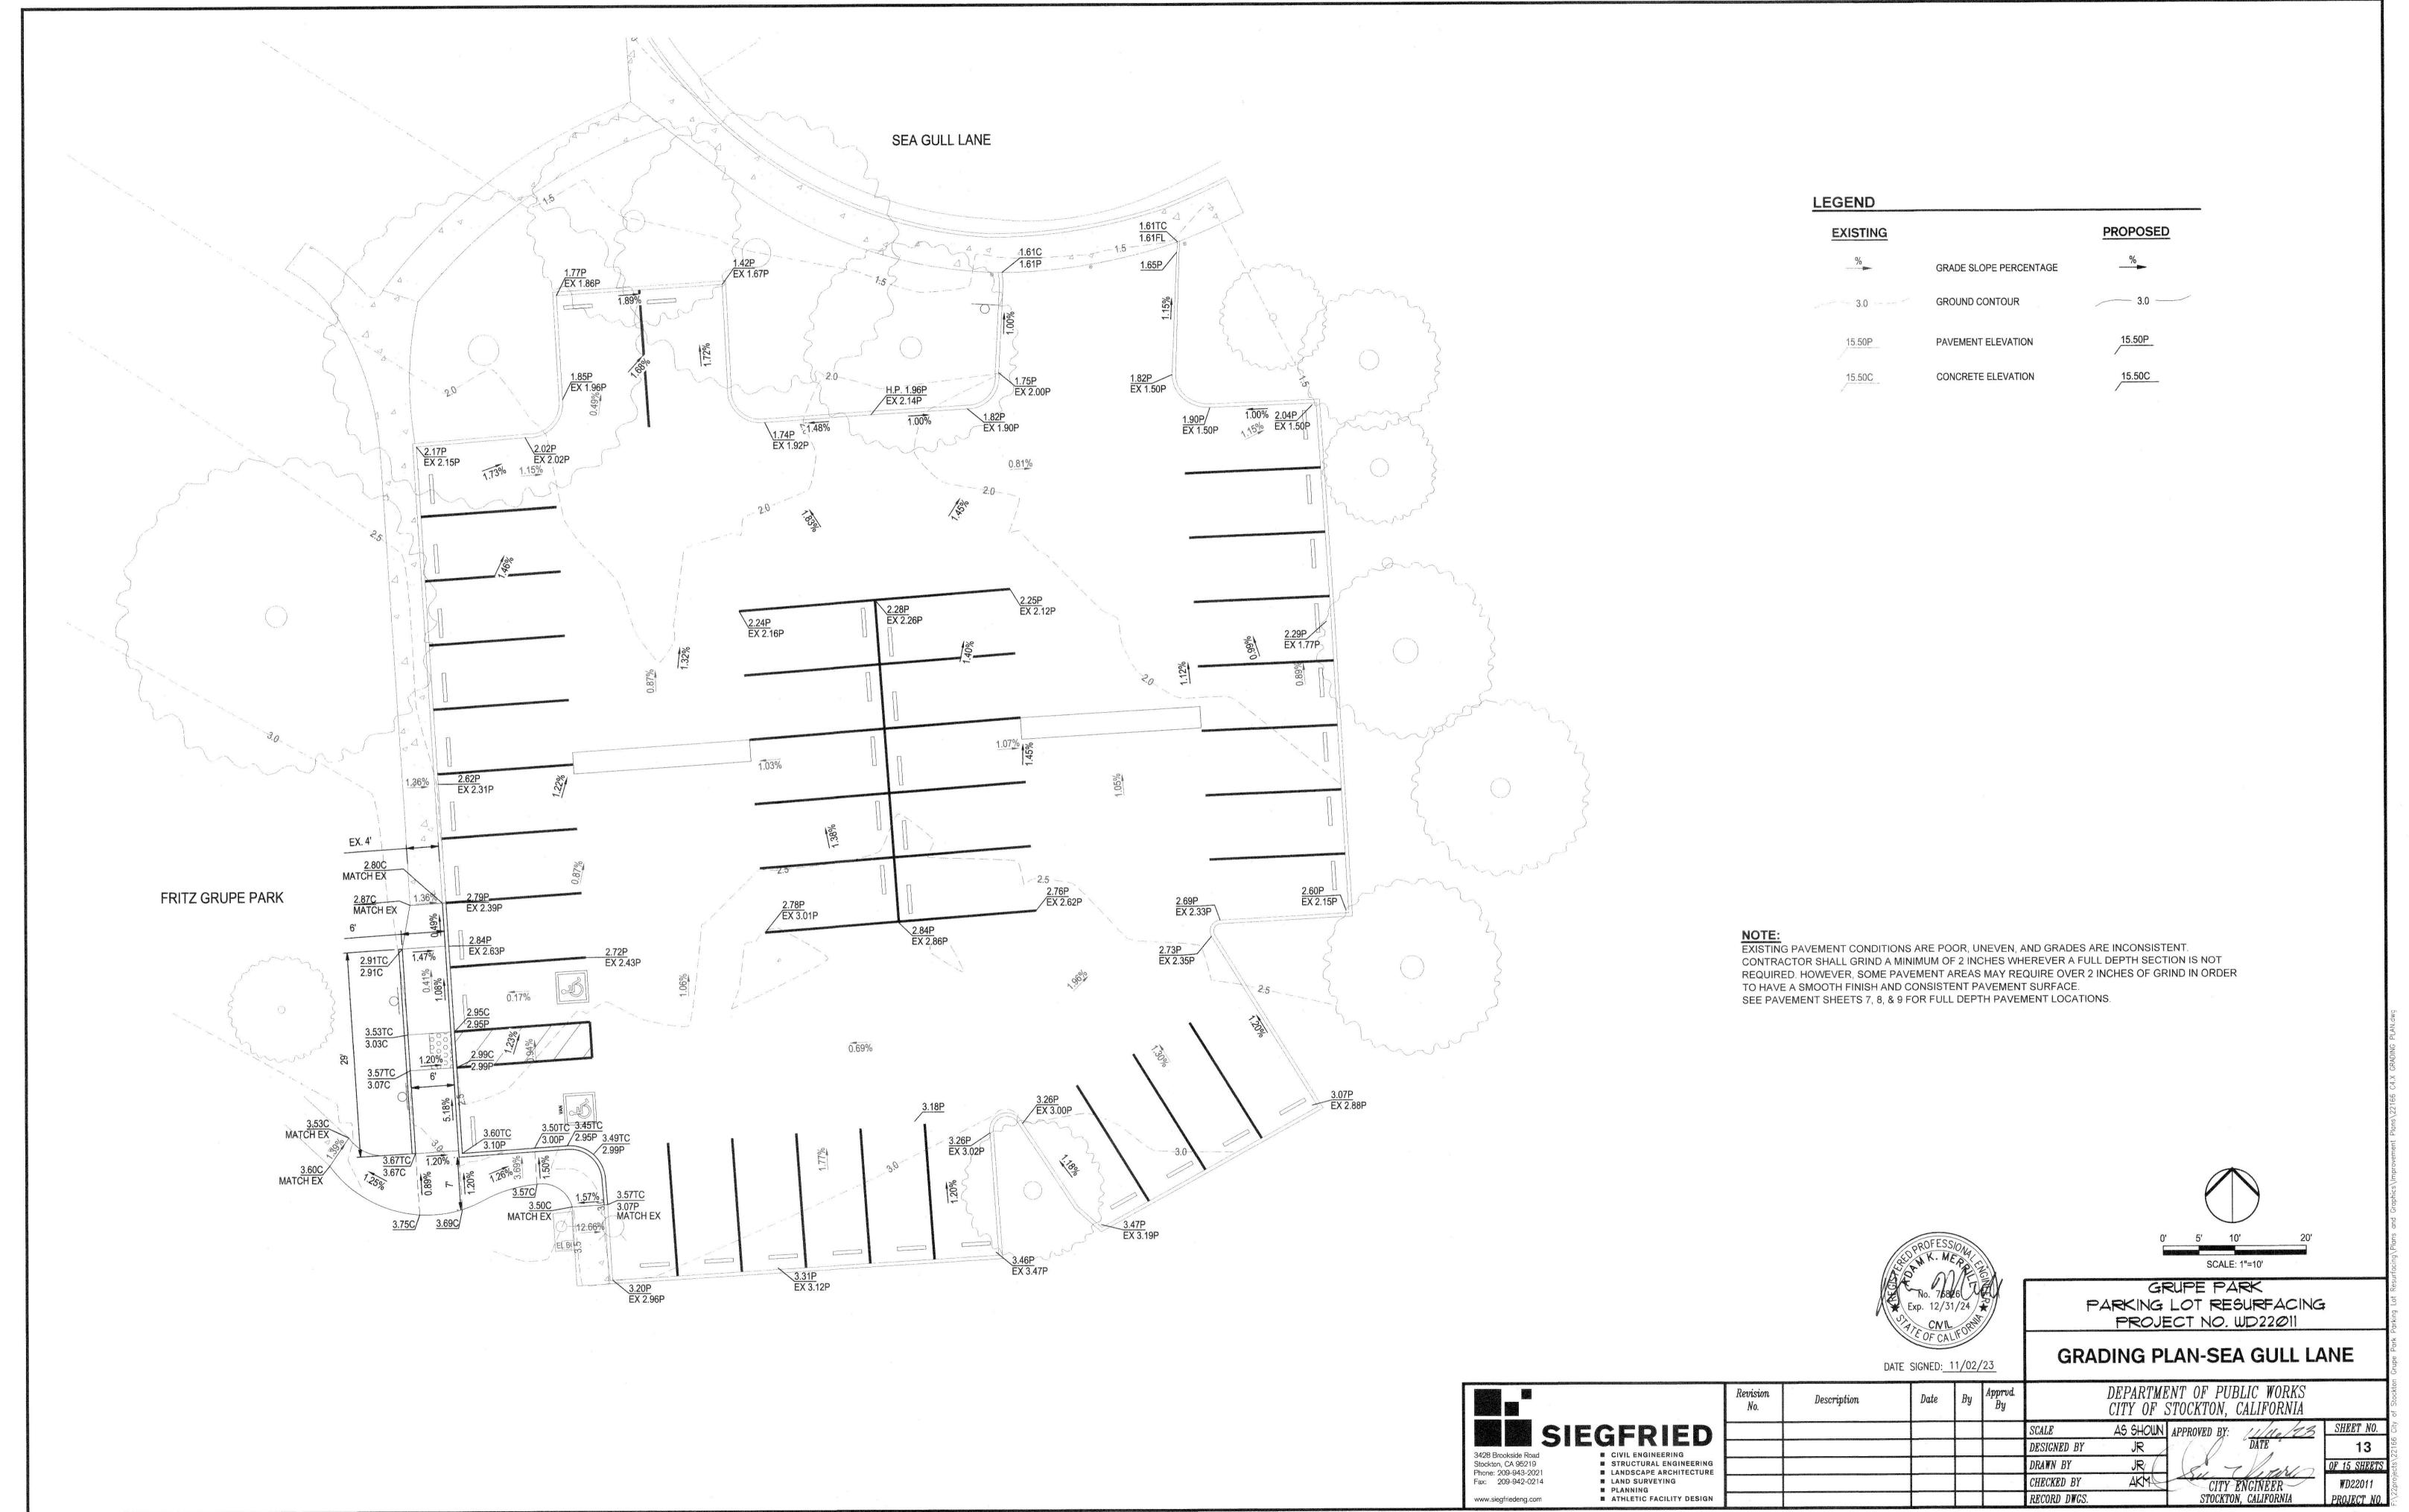

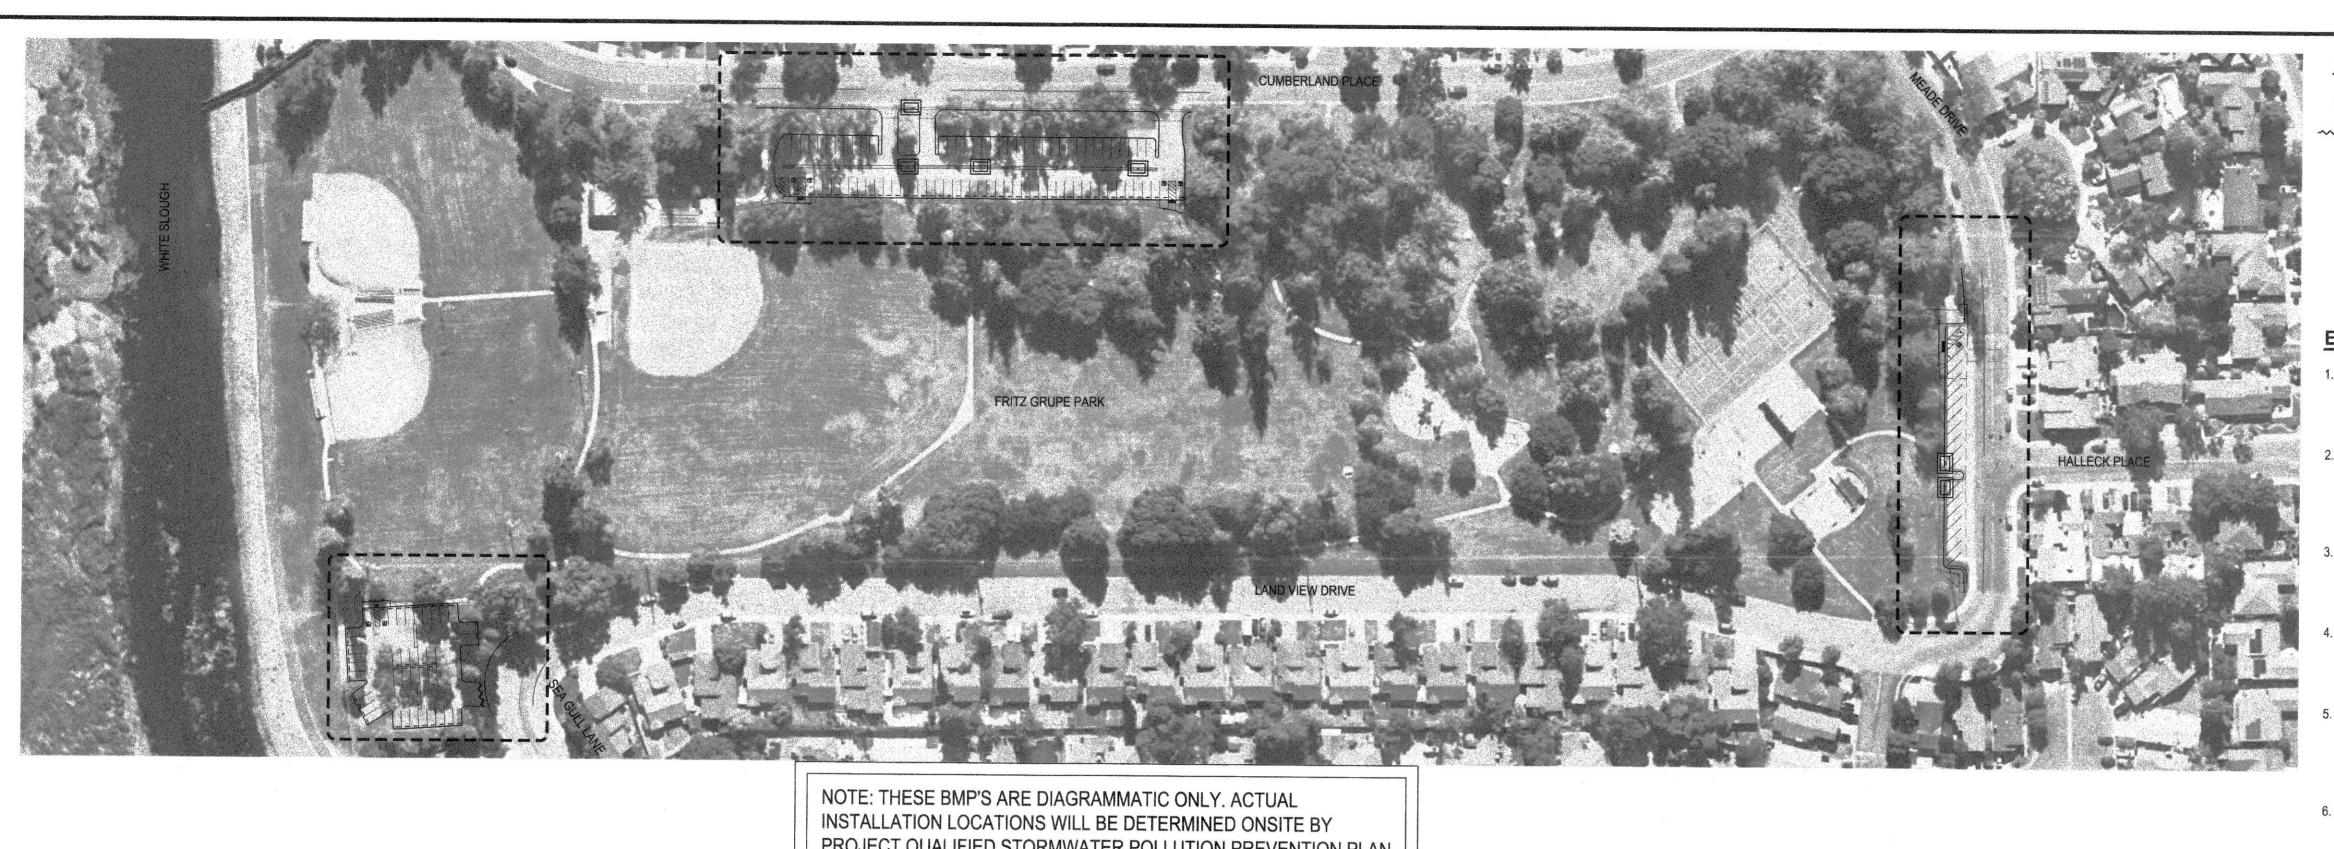

PROJECT QUALIFIED STORMWATER POLLUTION PREVENTION PLAN PRACTITIONER (QSP). ALTERNATIVE BMP'S THAT DO NOT ADHERE TO THESE DETAILS BUT COMPLY WITH CASQA AND THE INTENT OF THIS PLAN MAY BE SUPPLIED AND USED ON CONSTRUCTION SITE UNDER SUPERVISION OF PROJECT QSP.

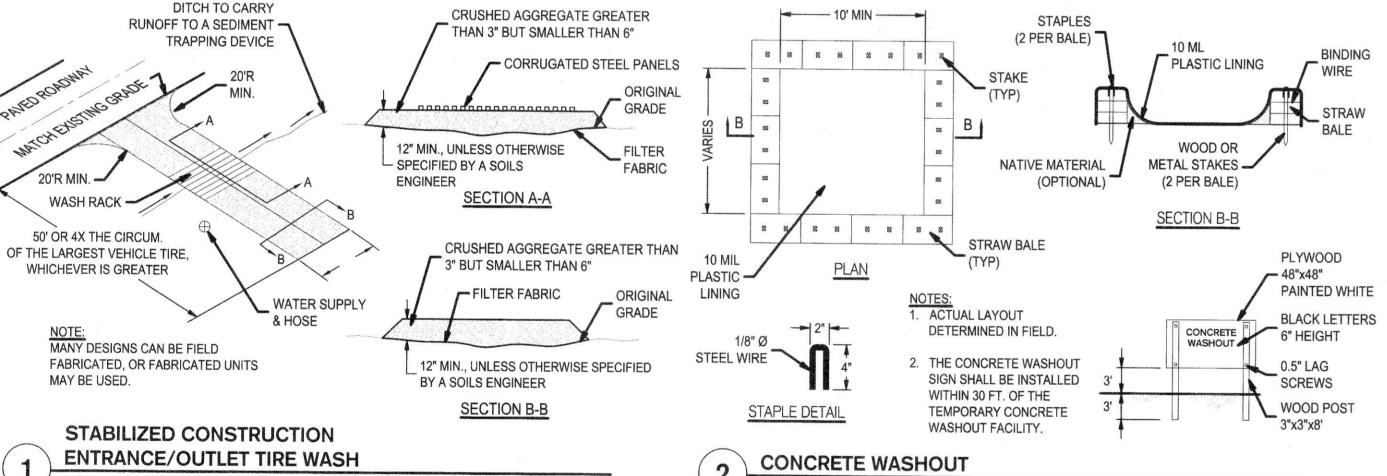

EXISTING

- DRAINAGE

GRATE

FILTERED

RUNOFF

SECTION C-C

RUNOFF WATER

WITH SEDIMENT

FILTER BAG

NO SCALE

12" LAP (MIN.) -

MAXIMUM BAG

DEPTH AT TOP OF

DRAIN

EXISTING AC PAVING

EXISTING DRAIN INLET -

FIBER ROLL 8" MIN. SLOPE 4" MAX. 3/4"x3/4" WOOD STAKES -MAX. 4' SPACING ENTRENCHMENT DETAIL

FIBER ROLLS

INSTALL A FIBER ROLL NEAR SLOPE WHERE IT TRANSITIONS INTO A STEEPER SLOPE VERTICAL SPACING MEASURED ALONG THE FACE OF THE SLOPE VARIES BETWEEN 10' AND 20' TYPICAL FIBER ROLL INSTALLATIO

SPILLWAY, 1-BAG HIGH

TYPICAL PROTECTION FOR INLET ON SUMP

SPILLWAY, 1-BAG HIGH

TYPICAL PROTECTION FOR INLET ON GRADE

5. NOT APPLICABLE IN AREAS WITH HIGH SILTS AND CLAYS WITHOUT FILTER FABRIC.

4. BAGS MUST BE REMOVED AFTER ADJACENT OPERATION IS COMPLETED.

EDGE OF PAVEMENT

NOTES:

1. INTENDED FOR SHORT-TERM USE.

2. USE TO INHIBIT NON-STORM WATER FLOW.

3. ALLOW FOR PROPER MAINTENANCE AND CLEANUP.

DI PROTECTION - TYPE 3

2-BAGS HIGH

2-BAGS HIGH

SE-10

SLOPE % ROLL SPACING 0-25 50 FT 25-50 15 FT 50% OF 10 FT **GREATER**

EROSION CONTROL LEGEND

DESCRIPTION

FIBER ROLLED WATTLE, SEE DETAIL 5 THIS SHEET ~~~~~~~


> GRAVEL BAG FILTER AT DROP INLET, SEE DETAIL 3 THIS SHEET

EROSION CONTROL GENERAL NOTES

- PLANS ARE DIAGRAMMATIC AND ARE NOT INTENDED TO SHOW ALL OFFSETS. THE SITE IS DYNAMIC AND CHANGES ON A DAILY BASIS, CHANGES SHOULD BE MADE ACCORDING TO EXISTING CONDITIONS. BECAUSE IT IS IMPOSSIBLE TO PREDICT ALL POSSIBLE SITUATIONS, CONTRACTOR SHALL USE BEST MANAGEMENT PRACTICES TO ENSURE QUALITY CONTROL.
- THE CONTRACTOR SHALL REVIEW THE CURRENT STORM WATER POLLUTION PREVENTION PLAN (SWPPP). IT IS THE CONTRACTORS SOLE RESPONSIBILITY FOR CONDUCTING HIS/HER OPERTATIONS IN ADHERANCE TO THE SWPPP. THE CONTRACTOR IS RESPONSIBLE FOR ANY FINES, DELAYS, AND/OR DAMAGES RESULTING FROM ANY STATE WATER QUALITY CONTROL BOARD SANCTIONS CAUSED BY
- THE FOLLOWING PLANS ARE ACCURATE FOR EROSION CONTROL PURPOSES ONLY. THE CONTRACTOR SHALL FOLLOW THESE PLANS UNLESS FIELD CONDITIONS DICTATE MODIFICATION. IF MODIFICATION IS NECESSARY, A SWPPP AMENDMENT MUST BE DONE. THIS MAY REQUIRE MODIFICATION TO THESE DRAWINGS AND ENGINEER CONCURRENCE.
- INSPECT AND REPAIR FILTERS AFTER EACH STORM EVENT. REMOVE SEDIMENT WHEN 1/2 OF THE FILTER DEPTH HAS BEEN FILLED. REMOVED SEDIMENT SHALL BE DEPOSITED IN AN AREA TRIBUTARY TO A SEDIMENT BASIN OR OTHER FILTERING MEASURE. SEDIMENT AND GRAVEL SHALL BE IMMEDIATELY REMOVED FROM PAVEMENT OF ROAD.
- UNFINISHED AND DISTURBED ARE TO BE PROTECTED WITH AN APPLICATION OF BLOWN STRAW AND ORGANIC BINDER.

ORGANIC BINDER

- 6. ALTERNATE INLET PROTECTION SHALL BE USED ON ROADS OPEN TO THE PUBLIC IF ANY HAZARDOUS MATERIALS OR WASTES WHICH HAVE BEEN TREATED, STORED, DISPOSED, SPILLED, OR LEAKED IN SIGNIFICANT QUANTITIES ONTO THE CONSTRUCTION SITE, THE CONTRACTOR SHALL BE RESPONSIBLE TO REMOVE THEM FROM THE SITE AND DISPOSE OF PROPERLY.
- 7. CHLORINATED OR DECHLORINATED WATER SHALL NOT BE DISCHARGED INTO THE STORM DRAIN SYSTEM. THE CONTRACTOR MAY DISPOSE THIS WATER INTO THE SANITARY SEWER SYSTEM UPON APPROVAL BY THE GOVERNING AGENCY.
- THE CONTRACTOR SHALL KEEP MAINTENANCE, INSPECTION, AND REPAIR PROCEDURES TO ENSURE THAT ALL GRADED SURFACES, WALLS, BERMS, DRAINAGE STRUCTURES, VEGETATION, EROSION AND SEDIMENT CONTROL MEASURES, AND OTHER CONTROLS ARE MAINTAINED IN GOOD AND EFFECTIVE CONDITION AND ARE PROMPTLY REPAIRED OR RESTORED WHEN NECESSARY. ANY DEWATERING WATER SHALL NOT BE DISCHARGED DIRECTLY INTO THE STORM WATER SYSTEM, AND SHALL NOT BE DISCHARGED INTO THE SEWER SYSTEM.
- 9. ALL DEWATERING WATER MUST BE CHANNELED THROUGH AN APPROVED SEDIMENT BARRIER PRIOR TO THE WATER ENTERING THE STORM SYSTEM
- 10. PAVEMENT CLEANING- FLUSHING OF STREETS/ PARKING LOTS TO REMOVE DIRT AND CONSTRUCTION DEBRIS IS PROHIBITED UNLESS PROPER SEDIMENT CONTROLS ARE USED. PREFERABLY, AREAS REQUIRING CLEANING SHOULD BE SWEPT.
- 11. ALL STOCKPILES OF MATERIALS THAT ARE NOT GOING TO BE USED FOR 14 DAYS SHALL BE COVERED.
- 12. CONTRACTOR TO USE BEST MANAGEMENT PRACTICES (BMPs) THROUGHOUT CONSTRUCTION, USE ALL BMPs THAT APPLY TO THE PROJECT, INCLUDING BUT NOT LIMITED TO THE FOLLOWING BMPs:
- A. DRAIN INLET PROTECTION CALIFORNIA STORMWATER BMP HANDBOOK SECTION SE-10
- B. SOLID WASTE MANAGEMENT CALIFORNIA STORMWATER BMP HANDBOOK SECTION WM-5 MATERIAL STORAGE - CALIFORNIA STORMWATER BMP HANDBOOK SECTION WM-1
- PAVING CALIFORNIA STORMWATER BMP HANDBOOK SECTION NS-3 E. DUST CONTROL, SEDIMENT CONTROL, EROSION CONTROL AND CONCRETE WASHOUT AREAS -
- SHOWN ON THIS SHEET WITH DETAILS
- 13. CONTRACTOR SHALL INSTALL DRAIN INLET PROTECTION FOR ALL CATCH BASINS LOCATED IN THE VICINITY OF WORK. THIS INCLUDES ANY CATCH BASINS LOCATED IN THE PUBLIC RIGHT-OF-WAY, AS WELL AS ANY ON-SITE CATCH BASINS LOCATED IN THE PARKING LOT.
- 14. CONTRACTOR SHALL ENSURE THAT CONSTRUCTION ACTIVITIES DO NOT DEPOSIT SEDIMENT ONTO THE PARKING LOT OR PUBLIC ROADWAY, SIDEWALK, AND GUTTERS.
- 15. CONTRACTOR SHALL USE STREET SWEEPING OR OTHER DRY-SWEEPING METHOD, AS NECESSARY, TO REMOVE CONSTRICTION-RELATED SEDIMENTS FROM PAVEMENT IN PROJECT AREA PARKING LOT AND PUBLIC SIDEWALKS, GUTTERS, AND ROADWAY.
- 16. CONTRACTOR SHALL SCHEDULE WORK FOR DRY-WEATHER DAYS WHEN NO RAIN IS IN THE IMMEDIATE FORECAST.

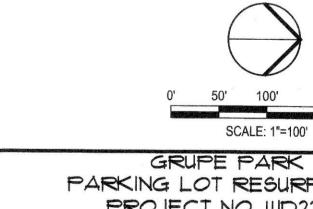

DATE SIGNED: 11/02/23

PARKING LOT RESURFACING PROJECT NO. WD22011

DEPARTMENT OF PUBLIC WORKS

EROSION CONTROL PLAN

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		EGFRI
	3428 Brookside Road	E CIVIL ENGINEERI
	Stockton, CA 95219	STRUCTURAL ENG
	Phone: 209-943-2021	M LANDSCAPE ARCH
	Fax: 209-942-0214	■ LAND SURVEYING

www.siegfriedeng.com

GINEERING CHITECTURE # PLANNING M ATHLETIC FACILITY DESIGN

Revision Description DESIGNED BY DRAWN BY CHECKED BY RECORD DWGS.

JR JR / AKM

CITY OF STOCKTON, CALIFORNIA AS SHOWN 1110/23 CITY ENGINEER STOCKTON, CALIFORNIA

EXISTING DRAINAGE

GRATE

TEMPORARY GRAVEL BAG FILTER AT DROP INLET

PLAN VIEW

FILTER BAG

WD22011

